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BALTIMORE CITY COUNCIL WAYS AND MEANS COMMITTEE

Mission Statement

The Committee on Ways and Means (WM) is responsible for ensuring taxpayer dollars are expended prudently and equitably. WM will exercise regular oversight of the City's budget, expenditures, loans, and other financial matters. The committee's areas of jurisdiction include: budget & appropriations, taxation, financial services, consumer protection, audits, and the Comptroller's Office.

The Honorable Eric T. Costello Chairman

PUBLIC HEARING

TUESDAY, September 10, 2024 10:02 AM

COUNCIL CHAMBERS

Council Bi!! #24-0560

Sale of Property - 1012 East 43rd Street

CITY COUNCIL COMMITTEES

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Staff: Marguerite Currin (443-984-3485)

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President Nick Mosby, Chair All City Council Members

Staff: Larry Greene (410-396-7215)

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Zeke Cohen Antonio Glover

Sharon Green Middleton

Phylicia Porter James Torrence

Staff: Deontre Hayes (410-396-1260)

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James Torrence

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LEGISLATIVE INVESTIGATIONS (LI)

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Staff: Marguerite Currin (443-984-3485)

Effective: 08/21/24 Revised: 08/21/24

CITY OF BALTIMORE

BRANDON M. SCOTT, Mayor



OFFICE OF COUNCIL SERVICES

LARRY E. GREENE, Director 415 City Hall, 100 N. Halliday Street Baltimore, Viaryland 21202 410-396-7215 / Fav: 410-545-7596 cmail: larry.greene@baltimorecity.gov

BILL SYNOPSIS

Committee: Ways and Means

Bill: 24-0560

Sale of Property – 1012 East 43rd Street

Sponsor: Department of Real Estate

Introduced: Jul 22, 2024

For the purpose of authorizing the Mayor and City Council of Baltimore to sell, at either public or private sale, all its interest in certain property that is located at 1012 East 43rd Street (Block 5192, Lot 059) and is no longer needed for public use; and providing for a special effective date.

Effective: On the date it is enacted

Agency Reports			
Law	Favorable		
Department of Housing and Community Development	Favorable		
Department of Finance	None as this writing		
Department of Planning	Favorable		
Department of Real Estate	Favorable		
Office of Equity and Civil Rights	Favorable		

Analysis

Current Law

Article V – Comptroller; Section 5(b); Baltimore City Charter; (1996 Edition) outlines the rules, regulations, and mandates for Sale of Properties.

Background

1012 East 43rd Street is in the 4th Council district in Baltimore City's Wilson Park neighborhood.

If approved, Council Bill 24-0560 would allow the sale of the property located at 1012 East 43rd Street (Block 5192, Lot 059) to KidzStuff Child Care Center. The property is a vacant grassy strip of land with a large overgrown tree located next to 1010 East 43rd Street, which is owned by KidzStuff Child Care Center. The organization would like to purchase the city-owned vacant property to expand its building at 1010 43rd for a new childcare center that will serve children with disability in an early learning center.

Also, see the attached pictures.

Additional Information

Fiscal Note: None.

Information Source(s): 24-0560, Baltimore City Code, and all agency reports received as of this

writing.

Analysis by: Niya N. Garrett Direct Inquiries to (410) 396-1268

Analysis Date: 09/05/2024



CITY OF BALTIMORE COUNCIL BILL 24-0560 (First Reader)

Introduced by: The Council President

At the request of: The Comptroller (Department of Real Estate) Introduced and read first time: July 22, 2024

Assigned to: Ways and Means Committee

REFERRED TO THE FOLLOWING AGENCIES: City Solicitor, Department of Finance, Department of Planning, Department of Housing and Community Development, Office of Equity and Civil Rights, Department of Real Estate

	A BILL ENTITLED
1	AN ORDINANCE concerning
2	Sale of Property – 1012 East 43 rd Street
3 4 5 6	FOR the purpose of authorizing the Mayor and City Council of Baltimore to sell, at either public or private sale, all its interest in certain property that is located at 1012 East 43 rd Street (Block 5192, Lot 059) and is no longer needed for public use; and providing for a special effective date.
7	By authority of
8	Article V - Comptroller
9	Section 5(b)
10	Baltimore City Charter
11	(1996 Edition)
12	SECTION 1. BE IT ORDAINED BY THE MAYOR AND CITY COUNCIL OF BALTIMORE, That, in
13	accordance with Article V, § 5(b) of the City Charter, the Comptroller of Baltimore City may
14	sell, at either public or private sale, all the interest of the Mayor and City Council of Baltimore in
15	the property located at 1012 East 43 rd Street (Block 5192, Lot 059), containing 5,201 square feet,
16	more or less of unimproved land, this property being no longer needed for public use.
17	SECTION 2. AND BE IT FURTHER ORDAINED, That no deed may pass under this Ordinance
18	unless the deed has been approved by the City Solicitor.
19	SECTION 3. AND BE IT FURTHER ORDAINED, That this Ordinance takes effect on the date it is
20	enacted.

Council Bill 24-0560

Agency Reports

SEE ATTACHED

CITY OF BALTIMORE

BRANDON M. SCOTT Mayor



DEPARTMENT OF LAW
EBONY M. THOMPSON, CITY SOLICITOR
100 N. HOLLIDAY STREET
SUITE 101, CITY HALL
BALTIMORE, MD 21202

September 3, 2024

The Honorable President and Members of the Baltimore City Council Attn: Executive Secretary Room 409, City Hall 100 N. Holliday Street Baltimore, Maryland 21202

Re: City Council Bill 24-0560 Sale of Property - 1012 East 43rd Street

Dear President and City Council Members:

The Law Department has reviewed Mayor and City Council Bill 24-0560 for form and legal sufficiency. The bill would allow the Mayor and City Council of Baltimore to sell its interest in the property located at 1012 East 43rd Street and declare it no longer needed for public use.

Article V, Section 5(b) of the Baltimore City Charter grants the Department of Real Estate in the Comptroller's Office the power to arrange for the disposition of any building or parcel of land no longer needed by the City for public use, if that sale is approved by the Board of Estimates. Assuming the agency reports reveal that the property is no longer needed for public use, this is the appropriate ordinance to authorize disposition of the subject property.

As there are no legal impediments to this bill, the Law Department can approve it for form and legal sufficiency.

Sincerely,

Desireé Luckey Assistant Solicitor

cc: Ebony Thompson, City Solicitor
Nina Themelis, Mayor's Office of Government Relations
Elena DiPietro, Chief Solicitor, General Counsel Division
Hilary Ruley, Chief Solicitor
Ashlea Brown, Chief Solicitor
Michelle Toth, Assistant Solicitor



CITY OF BALTIMORE MAYOR BRANDON M. SCOTT

TO	The Honorable President and Members of the Baltimore City Council
FROM	Alice Kennedy, Housing Commissioner
DATE	September 10, 2024
SUBJECT	24-0560 Sale of Property - 1012 East 43rd Street

The Honorable President and Members of the City Council City Hall, Room 400 9/10/24



Position: Favorable

Introduction

The Department of Housing and Community Development (DHCD) has reviewed City Council Bill 24-0560 Sale of Property - 1012 East 43rd Street for the purpose of authorizing the Mayor and City Council of Baltimore to sell, at either public or private sale, all its interest in certain property that is located at 1012 East 43rd Street (Block 5192, Lot 059) and is no longer needed for public use; and providing for a special effective date.

If enacted, City Council Bill 24-0560 would permit the Mayor and City Council of Baltimore to sell, at either public or private sale, all its interest in the property located at 1012 East 43rd Street. If approved, this ordinance will take effect the day it is enacted.

DHCD Analysis

1012 East 43rd Street is currently described as a narrow, vacant, and overgrown strip of land located within the Wilson Park neighborhood. KidzStuff, a full-service childcare provider, would like to purchase this city-owned property to expand the building it is currently remodeling at 1010 East 43rd Street. If completed, this facility will serve children with disabilities in an early learning center consisting of a 12,000-square-foot expansion to the already existing structure at 1010 East 43rd Street. This new addition would expand each floor by 4,000 square feet to include five classrooms, two therapeutic rooms for children and parents, accessibility ramps, and elevators. The grounds would consist of off-street parking at the rear of the properties and off-street drop-offs for families. KidzStuff currently operates directly across the street at 1009 East 43rd Street and serves approximately 60 families in the community. They have experienced a growing demand for childcare services and believe a new facility at 1010-1012 East 43rd Street

that focuses entirely on providing for special needs children will best serve that community.

This sales ordinance is at the request of The Comptroller (Department of Real Estate) and required for the disposition of the property. The property is not located within any of DHCD's Impact Investment Areas or Community Development Zones but is located within a Streamlined Code Enforcement Area. DHCD supports the disposition of the property as the site is no longer needed for public use.

Conclusion

DHCD respectfully request a **favorable** report on City Council Bill 24-0560.



CITY OF BALTIMORE MAYOR BRANDON M. SCOTT

TO	The Honorable President and Members of the Baltimore City Council			
FROM	Chris Ryer, Director, Department of Planning			
DATE	August 19, 2024			
SUBJECT	CCB #24-0560 - Sale of Property - 1012 East 43rd Street			

Position: Approval

SUMMARY OF POSITION

1012 East 43rd Street is located on the northwestern corner of the intersection with The Alameda. This property measures approximately 29'4" by 157'8" and is currently unimproved. This site is zoned R-5. This property has been undeveloped for decades. The sale of the property to the adjacent day care center owner will allow it to be developed and productively used, which will increase the City's tax base.

CONCLUSION

The Department of Planning respectfully requests a favorable report for this bill.

If you have any questions, please contact Mr. Eric Tiso, Division Chief, Land Use and Urban Design Division at eric.tiso@baltimorecity.gov or at 410-396-8358.



MEMORANDUM

To: The Honorable President and Members of the City Council

c/o Natawna Austin, Executive Secretary

From: Christine Griffin, Deputy Director of Policy and Government Relations, Office of the

Comptroller

Date: August 9, 2024

Re: CCB 24-0560 Sale of Property – 1012 East 43rd Street

Position: Favorable

The Department of Real Estate (DORE) is herein reporting on City Council bill 24-0560 Sale of Property – 1012 East 43rd Street (Block 5192, Lot 059), which is for the purpose of authorizing the Mayor and City Council of Baltimore to sell, at either public or private sale, all its interest in the property that is located at 1012 East 43rd Street and is no longer needed for public use; and providing for a special effective date.

Background

The DORE has received a request from KidzStuff Child Care Center asking the City to authorize the sale of 1012 East 43rd Street, a vacant grassy strip of land with a large overgrown tree. KidzStuff would like to use this city-owned property to expand its building at 1010 East 43rd for a new childcare center that will serve children with disabilities in an early learning center.

KidzStuff's proposed plan for 1012 East 43rd includes a 12,000-square-foot expansion to the existing structure at 1010 East 43rd, which is currently empty and has been completely gutted in preparation for renovation. With the expansion, each building floor would be expanded by 4,000 square feet to include five classrooms, two therapeutic rooms for children and parents, handicap-accessible ramps, and elevators. The grounds would consist of off-street parking at the rear of the properties and off-street drop-offs for families.

KidzStuff currently operates a full-service childcare center at 1009 East 43rd Street (across the street), serving approximately 60 families in the community. However, they have seen a growing demand and long waiting lists for childcare services for children with disabilities and they believe a new childcare facility at 1010-1012, focused only on children with disabilities, is necessary to best serve community needs.

In addition to this report, I have uploaded to Legistar the Acquisition Interest Form and the architectural plans KidzStuff submitted to DORE.

Ordinance

A City ordinance is necessary to authorize the sale of 1012 East 43rd Street. The purchase price will be subject to BOE approval and is not available at this time.

The Department of Real Estate respectfully requests a favorable report enabling this ordinance.



CITY OF BALTIMORE MAYOR BRANDON M. SCOTT

TO	The Honorable President and Members of the Baltimore City Council
FROM	Caron Watkins Interim Director, Office of Equity & Civil Rights Interim Chief Equity Officer
ANALYST	Zachary Wellman Equity Policy Analyst, Office of Equity & Civil Rights
DATE	August 29, 2024
SUBJECT	OECR Report on Baltimore City Council Bill 24-0560 Sale of Property - 1012 East 43 rd Street

OECR POSITION: Favorable

SUMMARY OF LEGISLATION

The Office of Equity & Civil Rights (OECR) has reviewed and is herein reporting on City Council Bill 24-0560 - *Sale of Property - 1012 East 43rd Street*. This is a property sale bill for the plot located at 1012 East 43rd Street (Block 5192, Lot 059).

The bill seeks to accomplish the following:

- Authorize the Mayor and City Council to sell, either at public or private sale, all its interest in the property.
- Provide an effective date for the sale (effective immediately upon passage).
- Require the City Solicitor to approve the transfer of the property deed.
- Allow the undeveloped property to be reused.

The bill enables the Mayor and City Council to divest their interests in the property by way of sale through the authority of the Comptroller, as outlined by Article V, Section 5(b) of the Baltimore City Charter.

ANALYSIS

Council Bill 24-0560 seeks to authorize the sale of the city property located at 1012 East 43rd Street, a plot of undeveloped land, with the intent it will be sold to KidzStuff Child Care Center. The OECR recognizes that KidzStuff Child Care Center submitted an Acquisition Interest Form to the Department of Real Estate for the property to expand their adjacent empty facility located at 1010 East 43rd Street and accompany their in-use childcare facility across the street at 1009 East 43rd Street.

KidzStuff Child Care Center has promised to establish an early learning center for children with disabilities on the acquired plot, which would include five classrooms and two therapeutic rooms for parents and children. In line with the intended use of the property, the new facility would include accessibility features such as accessible ramps, elevators, and off-street parking.

KidzStuff Child Care Center currently serves its community by providing childcare to families in Northeast Baltimore; however, its current facility is under-equipped to provide care to children with disabilities. The sale of the property at 1012 East 43rd Street is a necessary step to enable KidzStuff Child Care Center to provide equitable care for children with and without disabilities alike. Therefore, the intended outcome of Council Bill 24-0560 should have a positive impact on the equity of Baltimore City residents, particularly young residents living with disabilities, and their families.

CONCLUSION

After review, the Office of Equity & Civil Rights has discerned no inequity in the intent of the property sale and supports the intended use of the property to provide care for children with disabilities in Baltimore once sold. As such, the office requests a **favorable** committee report on City Council Bill 24-0560.

Respectfully Submitted,

Interim Director, Office of Equity & Civil Rights

Caron Watkins

Council Bill 24-0560

Additional Materials

SEE ATTACHED

ACQUISITION INTEREST FORM

Name of Applicant: Angela Kidane
If a corporation, or partnership, specify the name and title of the principal contact person:
Scarlet Covering Inc, dba KidzStuff Child Care Centers
Address: 1009 East 43rd Street City: Baltimore State: MD Zip: 21212
Phone: (Mobile) 443.386.5928 (Work) 410.800.2142
Email: angela@scarletcovering.com Fax # 410.728.2432
Address of Property: 1012 E. 43rd Street
Block, Lot: 5192/59

In order for us to adequately evaluate your request to purchase a City-owned property or tax sale certificate for foreclosure, you must provide adequate information regarding your intentions with regard to the property, your resources for carrying out those plans, and your experience in the type of project you propose. Therefore, using as many pages as required, please provide detailed responses to the following questions and attach required back-up information, as requested. Please number your responses to correlate to the questions.

1. Describe the property and provide information in <u>DETAIL</u> as to how you will use the property (rental unit, owner-occupied home, extended yard space, for parking, for community-based program, etc.

The city owned property is currently a strip of grassy area with a very large overgrown tree. Scarlet Covering, Inc. will use the city owned property to expand the building on the lot to the left of the property. The expanded property will serve children with disabilities in an early learning center. The new center will include handicap accessible ramps and parking. The new center will also include a total of five classrooms and two therapeutic rooms for children and parents.

- 2. If you intend to develop the property, you <u>must</u> answer questions 3-7 and complete the attached Development Pro Forma. Otherwise, please go to question number 8.
- 3. Describe any prior development experience you have had, or the consultants or development team you propose to use for your project.

Scarlet Covering, Inc developed the property at 1009 East 43rd Street (across the street from the vacant city lot), developed it to code and opened a childcare center inside. The childcare center has been operating since 2022. Additionally, at 1900 N Broadway # 100, Baltimore, MD 21213 we operate a 12,000 SF childcare space in the former grocery store footprint. For this project at 1010-1012 we have hired Sulton Campbell Britt & Associates, P.C. as the architecture firm for this project and Bear Home Improvement as the general contractor.

4. Describe how your proposed use conforms to the existing zoning on the site. In order to check on zoning and any requirements for your proposed use (such as off-street parking), you may consult Zoning Office on the first floor of the Benton Building at 417 E. Fayette Street. You may also want to check with the Community Planner for your area in the Department of Planning on the eighth floor of the Benton Building.

The property was zoned for childcare in the past with an approved license from MSDE Office of Childcare, the new project will be a childcare center. The adjacent lot and the lot across the street are zoned for childcare.

5. Please describe proposed renovation or construction plans for the site. If the plan is a renovation of an existing property, please provide details of that renovation. If you are proposing new construction, please provide a description of the new structure, its size (# of stories, square footage, etc), and a description of materials. Provide details of off-street parking provisions.

The proposed plan will include a 12,000 square foot expansion to the existing structure on 1010 which will expand onto 1012. Each floor of the building will be expanded by 4,000 square feet. The grounds will include off-street parking in the rear of the properties and off street drop off for families utilizing the services at the center. (the initial plans for the building are attached)

- 6. Provide a **<u>DETAILED</u>** cost estimate of the project including hard and soft costs. See the attached project pro forma for development. If this is to be an income-producing property or a service facility, you must also provide a projected operating budget and specify sources of funds available for operations as well.
- 7. Provide evidence of availability of funds to complete project. Specify sources of funds and attach evidence of commitments from financial institutions or bank statements showing available cash.

The project will be funded through Scarlet Covering, Inc. operating funds and savings (bank statements attached). The project also received funding from the Maryland Consolidated Capital Bond Loan (MCCBL) of 2023 (proof attached)

8. Provide a **<u>DETAILED</u>** time-line for completion of the proposed project.



- 9. List any other property you own in the City of Baltimore. For each property provide the following information:
 - Address, and term of ownership.
 1009 East 43rd Street, 2021 to present
 1010 East 43rd Street, 2021 to present
 - b. Whether all taxes and municipal liens are current.
 All taxes and municipal liens are current
 - c. Is property vacant and under notice to raze or repair from the Department of Housing and Community Development? \mathbf{No}

Please note that in reviewing your request, the City will consider your compliance with local repair and maintenance codes, and payment of taxes on property already in ownership.

10. Has the adjacent owner(s) of the property	y been informed of your interest and plan	ns?
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Yes X No

11. Do you have a letter(s) of support from adjacent owners and relevant community associations? If yes, please submit supporting letters. Yes ____ No X (If no, provide an explanation.)

We have attempted to reach out to the community association however we have learned the previous president has died and the current president is in the hospital. We have spoken to the association president from two terms ago.

Please return your completed application to

DEPARTMENT OF REAL ESTATE 100 N. HOLLIDAY STREET, ROOM 304 BALTIMORE, MD 21202 410-396-4768 -Cathy Zoppo FAX: 410-528-1437

NOTE: All questions on this application must be answered in <u>DETAIL</u> for any request to be considered. Incomplete applications will <u>NOT</u> be considered.

Outline of Development Pro Forma for the Property Known As:

Uses ¹	Amount ²	Source of Funds ³
Property Acquisition (including tax sale foreclosure costs and closing and recording fees)	\$1,000.00	1010 E 43 rd Street (owned)
Architectural	\$75,000.00	Operating Funds
Engineering	\$25,000.00	Operating Funds
Environmental testing & disposal	\$0	
Demolition	\$13,500.00	Operating Funds
Construction (specify building square footage and PSF costs of construction or renovation) PSF. If available, attach a contractor's proposal or costed construction write-up	\$500,000.00	Savings and State Bond Bill
Legal	\$2,500.00	Operating Funds
Appraisal	\$1,200.00	Operating Funds
Financing Fees	\$0	
Permit fees	\$3,000.00	Operating Funds
Insurance	\$3,750.00	Operating Funds
Taxes during construction	3,800.00	Operating Funds
Water during construction	\$2,500.00	Operating Funds
Security	\$0	
Utilities during construction	\$3,500.00	Operating Funds
Costs of Resale: ⁴ Advertising Real Estate Commission (%) Seller's closing costs	N/A	

¹ Note that not all lines may be applicable depending upon the nature of the project and its eventual intended use

² You should provide on a separate attached sheet your assumptions for obtaining this cost estimate, for instance, Taxes during construction should specify the monthly amount of taxes and the construction period assumed in calculating the amount needed during construction; or financing fees should be broken down into application fees, points, etc.

³ Specify the sources of funds for each line item – bank loan, cash, and sweat equity. ⁴ Specify below the intended sale price of the property.

KidzStuff Child Care


1010 East 43rd Street, Baltimore, Maryland







SULTON CAMPBELL BRITT & ASSOCIATES, P.C. Architecture * Historic Preservation * Planning * LEED™ Consulting

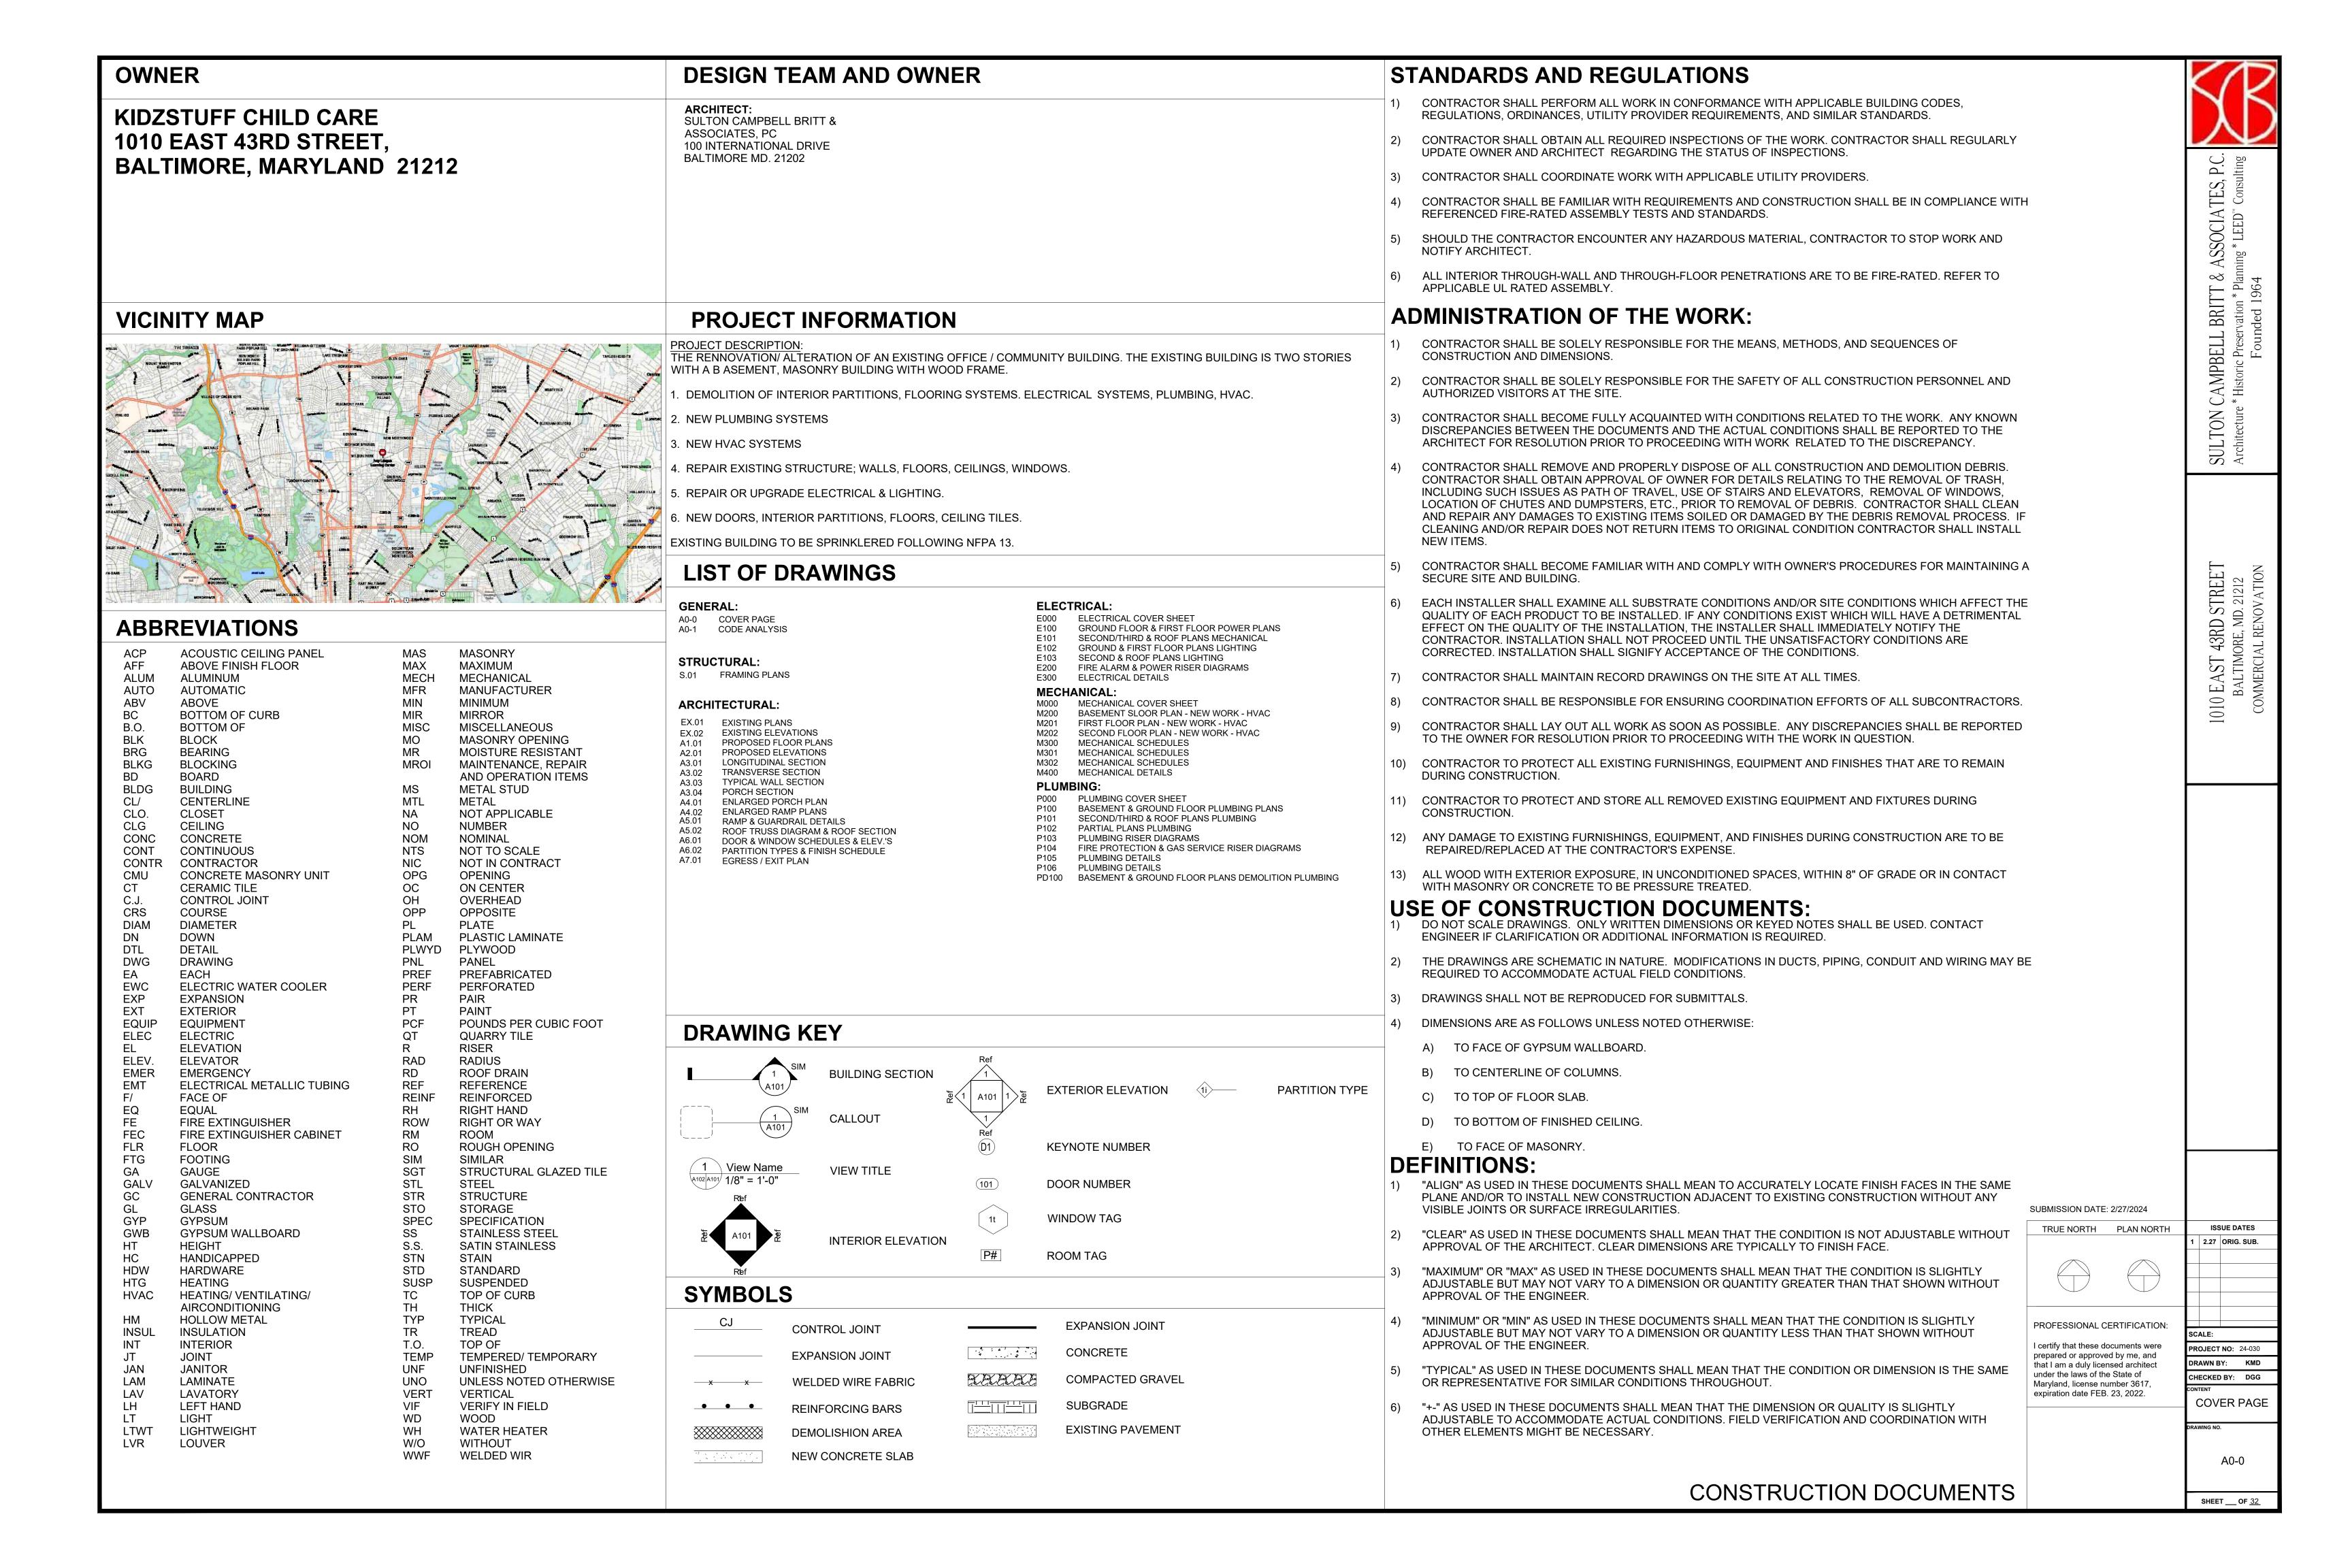

BUILDING CODE ANALYSIS GOVERNING CODES & STANDARDS

BUILDING CODES

THIS BFR CODES ARTICLE (2015 EDITION) COMPRISES THE FOLLOWING STANDARS AND CODES, AS SUPPLEMENTED, AMENDED , OR OTHERWISE MODIFIED BY THE MAYOR AND COUNCIL OF BALTIMORE

MBPS (2019) MARYLAND BUILDING PERFORMANCE STANDARDS / JANUARY 2019

IBC (2018) INTERNATIONAL BUILDING CODE / 2018

IEBC (2018) INTERNATIONAL EXISTING BUILDING CODE / 2018 (MARYLAND BUILDING REHAB CODE)

NEC (2017)

NATIONAL ELECTRICAL CODE / 2017

IFGC (2018)

INTERNATIONAL FUEL GAS CODE / 2018

IMC (2018)

INTERNATIONAL MECHANICAL CODE / 2018

IPC (2018)

INTERNATIONAL PLUMBING CODE / 2018

IPMC (2018) INTERNATIONAL PROPERTY MAINTENANCE CODE / 2018

IFC (2018) INTERNATIONAL FIRE CODE / 2018

IECC (2018) INTERNATIONAL ENERGY CONSERVATION CODE / 2018
IGCC (2015) INTERNATIONAL GREEN CONSTRUCTION CODE / 2015


FIRE CODES

IFC 2018 INTERNATIONAL FIRE CODE 2018

ACCESSIBILITY CODES

ADAAG (2010) ACCESSIBILITY: (AMERICANS DISABILITY ACT) AND "FHAA" (FEDERAL FAIR HOUSING


AMENDMENTS ACT OF 1988)

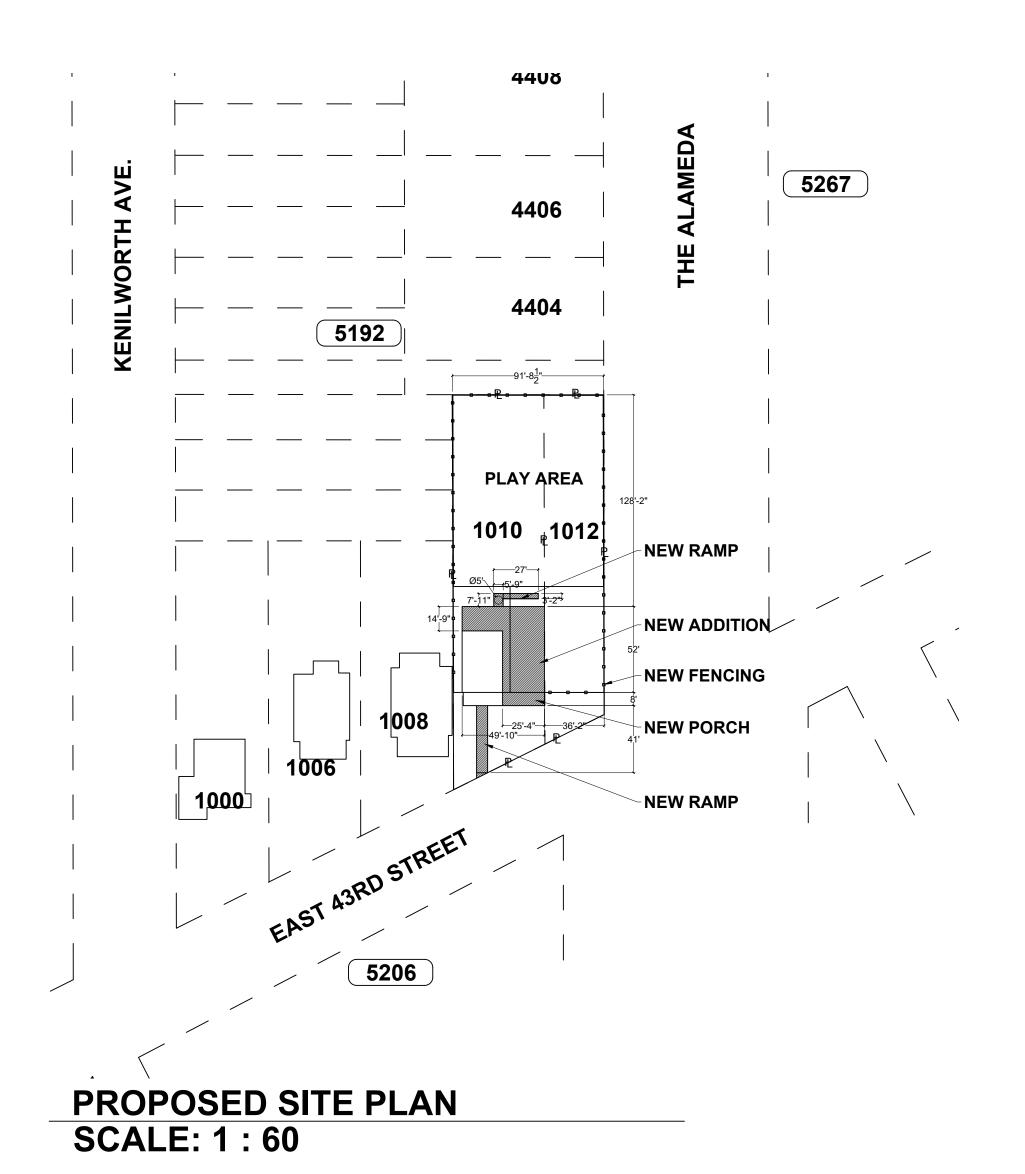



BUILDING DESIGN TOPIC OCCUPANCY	EXISTING	ALLOWABLE	PROPOSED	CODE REFERENCE		<r< th=""></r<>
				IDC 200 F		
OCCUPANCY CLASSIFICATION	S-1 (BASEMENT LEVEL)	I-4 (BASEMENT LEVEL)	I-4 (BASEMENT LEVEL)	IBC 308.5		P.C.
	B (FIRST LEVEL) B (SECOND LEVEL)	I-4 (FIRST LEVEL)	I-4 (FIRST LEVEL) I-4 (SECOND LEVEL)	IBC 308.5		
CONSTRUCTION	B (SECOND LEVEL)	I-4 (SECOND LEVEL)	1-4 (SECOND LEVEL)	IBC 306.5		ATE
CONSTRUCTION TYPE	IIIB	IIIB	IIIB	IBC 602		ASSOCIATES,
HIGH-RISE	N/A	N/A	N/A			ASS ing *
SPRINKLERS	NO	REQUIRED FOR I-4	YES	IBC 903.2.6		TT & ASGA Planning 1964
ALARM SYSTEM	NO	REQUIRED FOR I-4	YES	IBC 907.2.6		
HEIGHT (FEET)	30' +/-	30 FT W/ SPRINKLER (I-4)	30' +/-	IBC TABLE 504.4		L B Servat
HEIGHT (STORIES)	3 STORIES + BASEMENT	3 W/ SPRINKLER (I-4)	3 STORIES + BASEMENT			CAMPBELL BRIT * Historic Preservation Founded 19
FLOOR AREA	4,855 SF TOTAL	39,000 SF	4,855 SF TOTAL	IBC TABLE 506.2		\\\\\\\\\\\\\\\\\\\\\\\\\\\\\\\\\\\\\\
FIRE-RESISTANCE RATING OF ELEMENTS	NONE	SPRINKLER	SPRINKLER			
PRIMARY STRUCTURAL FRAME	0HR	0HR	0HR	IBC TABLE 601		SULTON
BEARING WALLS	2HR	2HR/0HR	2HR/0HR	IBC TABLE 601		S
NONBEARING WALLS	0HR	0HR	0HR	IBC TABLE 601, TABLE 602		
FLOOR CONSTRUCTION	0HR	0HR	0HR	IBC TABLE 601/ 508.4		
ROOF CONSTRUCTION	0HR	0HR	0HR	IBC TABLE 601		r .
EXTERIOR WALLS X < 5	2HR	2HR	2 HR	IBC TABLE 602		EET 2 ION
EXTERIOR WALLS 5 ≤ X 10	2HR	1HR	1HR	IBC TABLE 602		1010 EAST 43RD STREET BALTIMORE, MD. 21212 COMMERCIAL RENOVATION
EXTERIOR WALLS 10 ≤ X 30	1HR	1HR	1HR	IBC TABLE 602		43RD RE, MD.
EXTERIOR WALLS X ≥ X 30	0HR	0HR	0HR	IBC TABLE 602		EAST 43RD ALTIMORE, MD. MERCIAL RENO
FIRE WALL (PARTY)	N/A	N/A	N/A	IBC TABLE 706.4.a		SAST LTIMC ERCIA
FIRE BARRIER SEPERATION	0HR	NONE	NONE	IBC TABLE 508.4		1010 E BAL COMME
CORRIDOR FIRE RESISTANCE	1HR	0HR	N/A	IBC TABLE 1020.1, NFPA 30	.2.2.1.2	
MEANS OF EGRESS COMPONENTS (EXIT ENCLOSURES & DOORS)	1HR	1HR	1HR	NFPA 30.2.2.1.2		
FIRE SEPARATION ASSEMBLIES	1HR	1HR	1HR	IBC TABLE 508.4, NFPA 6.1.	14.4.1 (A)	
MEANS OF EGRESS	3					
OCCUPANT LOAD LOCATION	SQUARE FOOTAGE	OCCUPANT LOAD	PP			
(I-4) BASEMENT LEVEL	1,241 SF (35 OCC.)	35 SF NET	35 OCC.	IBC 311.1, TABLE 1004.5		
(I-4) FIRST LEVEL	1,565 SF (44 OCC.)	35 SF NET	44 OCC.	IBC 303.1.2, 304.1, TABLE 10	004.5	
(I-4) SECOND LEVEL	1,315 SF (37 OCC.)	35 SF NET	37 OCC.	IBC 303.4, TABLE 1004.5		
(I-4) THIRD LEVEL MEANS OF EGRESS SIZING	734 SF (20 OCC.)	35 SF NET	20 OCC.	IBC 303.4, TABLE 1004.5		
STAIRS	63"	44" MIN.	63"	IBC 1011.2		
CORRIDOR	5' 9"	44" MIN.	44" MIN.	IBC TABLE 1020.2		
DOORS	32" DOORS	32" MIN.	36"	IBC 1005.3.2		
LICED COOLD		# OF DEOLUDED EVITO	# DDODOSED			
USER GROUP BASMNT. LEVEL (I-4)	2 EXITS	# OF REQUIRED EXITS 2	# PROPOSED 2	IBC 1006.2.1 EXCEPTION 1, 7 1006.3.2 (2)	ΓABLE	
1ST LEVEL (I-4)	2 EXITS	2	2	IBC TABLE 1006.2.1		
2ND LEVEL (I-4)	2 EXITS	2	2	IBC TABLE 1006.2.1	SUBMISSION DATE: 2/27/2024 TRUE NORTH PLAN NORTH	REVISIONS
THIRD LEVEL (I-4)	2 EXITS	2	2	IBC TABLE 1006.2.1	TROUNDATT FLAN NORTH	1 2/27 ORIG. SUB.
MINIMUM NUMBER	OF REQUIRED	PLUMBING FIXT	URES			2
TOPIC	EXISTING	ALLOWABLE	PROPOSED	CODE REFERENCE		
MEN WATERCLOSETS	N/A	1 PER 15 (136 OCC.)= 9 MIN.	9 ADA WC	IBC 2902.1, TABLE 2902.1	PROFESSIONAL CERTIFICATION:	SCALE: AS NOTED
WOMEN WATERCLOSETS	N/A	1 PER 15 (136 OCC.)= 9 MIN.	9 ADA WC	IBC 2902.1, TABLE 2902.1	I certify that these documents were prepared or approved by me, and that I am a duly licensed architect	PROJECT NO: 21-010 DRAWN BY: Author
MEN LAVATORIES	N/A	1 PER 15 (136 OCC.)= 9 MIN.	9 ADA WC	IBC 2902.1, TABLE 2902.1	under the laws of the State of Maryland, license number 3617, expiration date FEB. 23, 2022.	CHECKED BY: Checker
WOMEN LAVATORIES	N/A	1 PER 15 (136 OCC.)= 9 MIN.	9 ADA WC	IBC 2902.1, TABLE 2902.1		CODE ANALYSIS
DRINKING FOUNTAINS	N/A	1 PER 100 (136 OCC.)= 2 MIN.	2	IBC 2902.1, TABLE 2902.1		DRAWING NO.
SERVICE SINKS	N/A	1 SERVICE SINK	1	IBC 2902.1, TABLE 2902.1		A0-1

CONSTRUCTION DOCUMENTS

SHEET ___ OF <u>37</u>

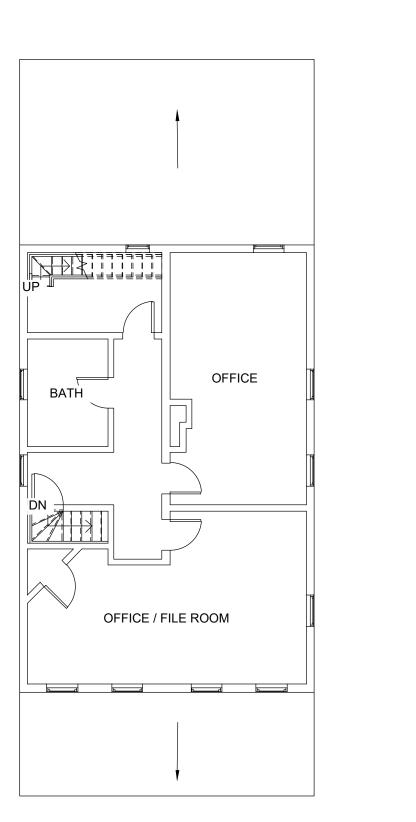

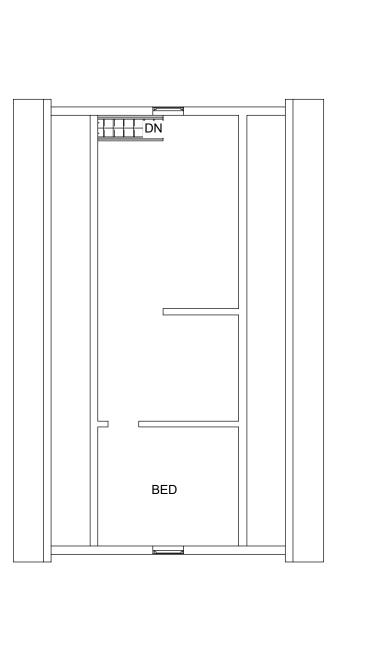

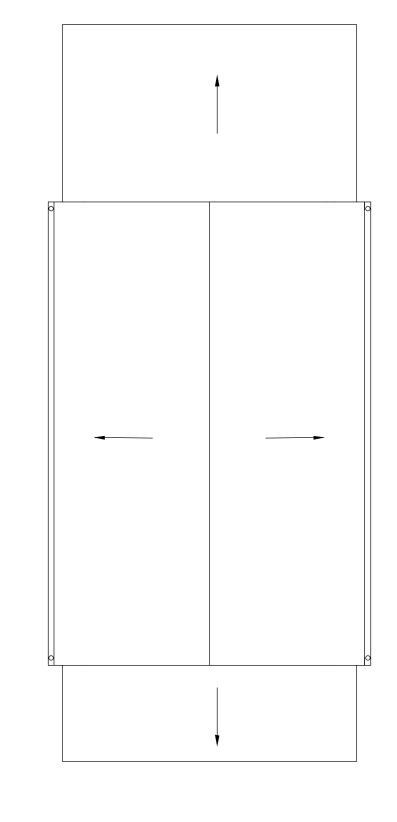






CLASS ROOM

CUBBIES

PLAY ROOM

LIVING ROOM

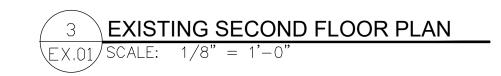





ISSUE DATES

1 2.27 ORIG. SUB.

SCALE:

PROJECT NO:

DRAWN BY: KMD

CHECKED BY: DGG

CONTENT

EXISTING PLANS


DRAWING NO.

EX.01


SHEET <u>3</u> OF <u>32</u>



SHEET <u>8</u> OF <u>32</u>

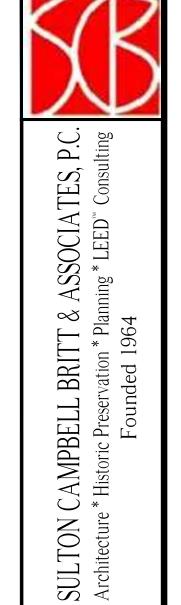

1010 EAST 43RD STREET BALTIMORE, MD. 21212 COMMERCIAL RENOVATION

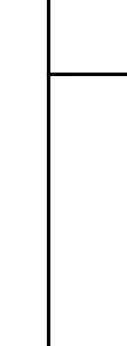



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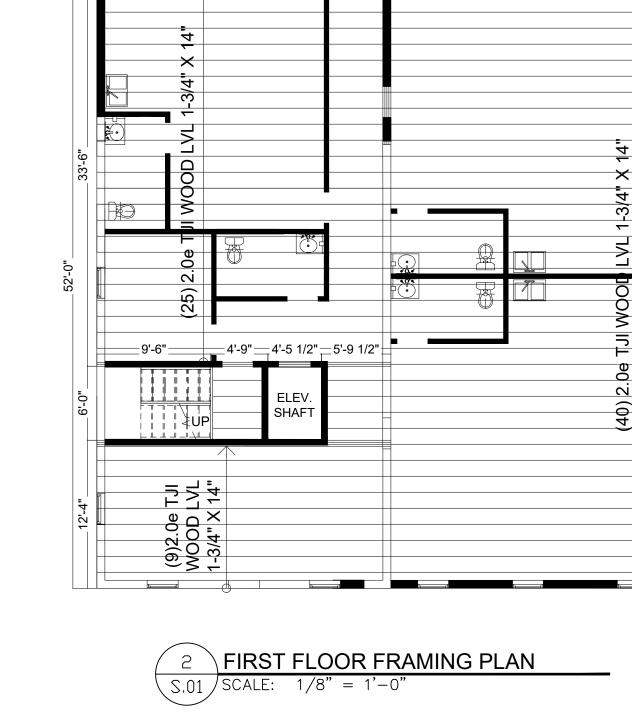
PROJECT NO: CHECKED BY: DGG FRAMING PLANS


S.01


SHEET <u>5</u> OF <u>32</u>



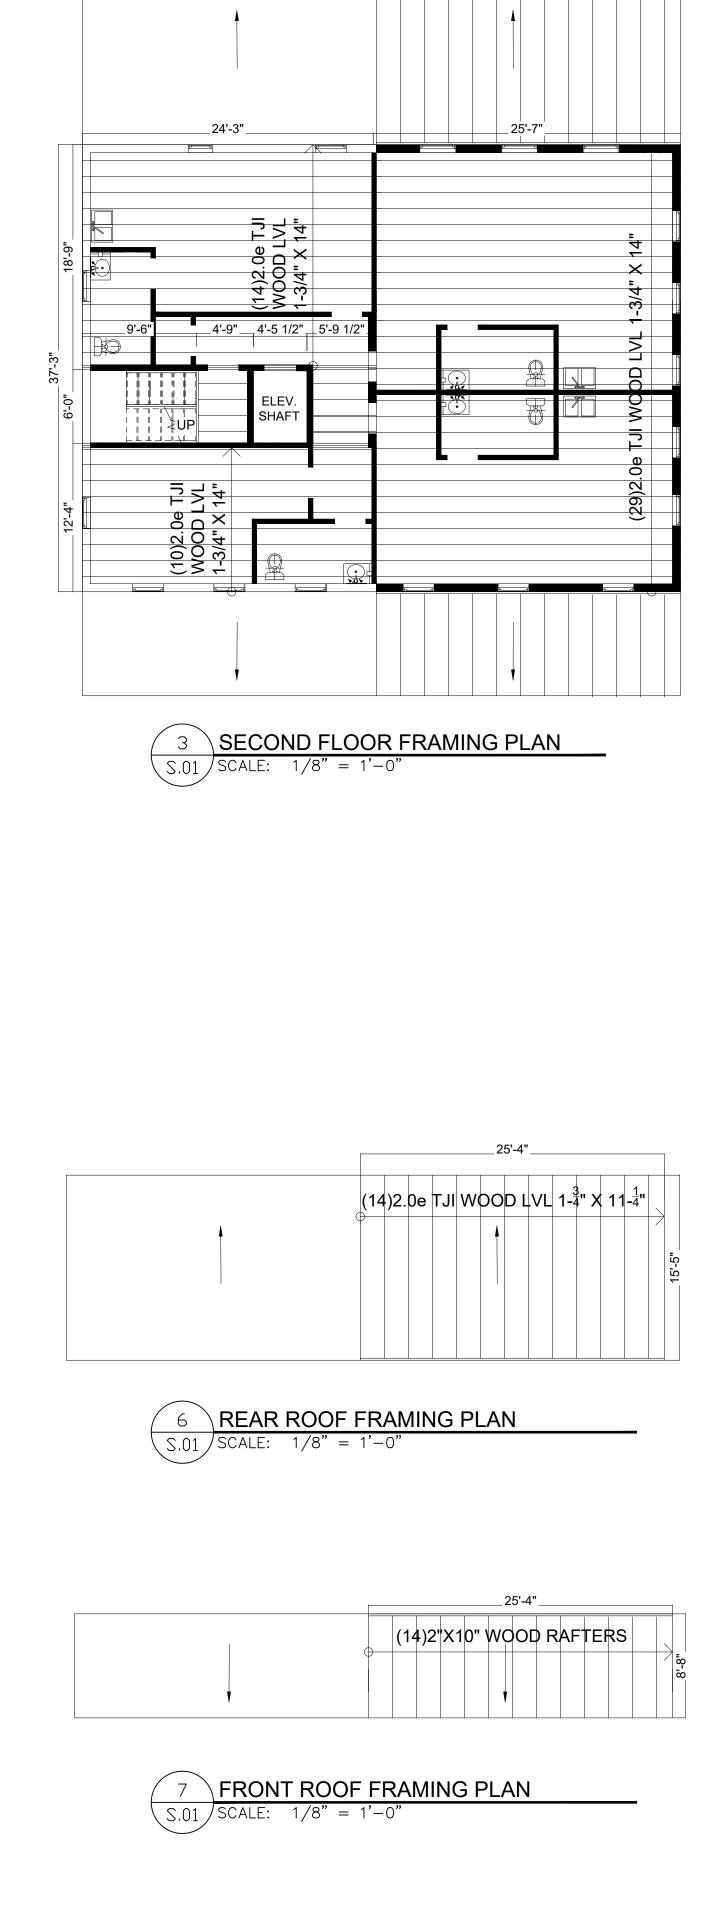

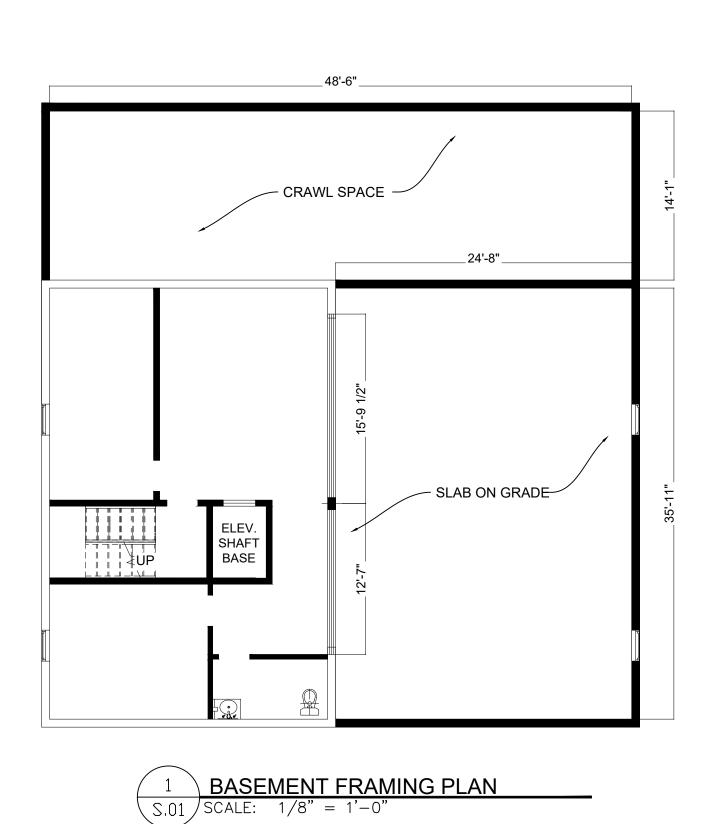

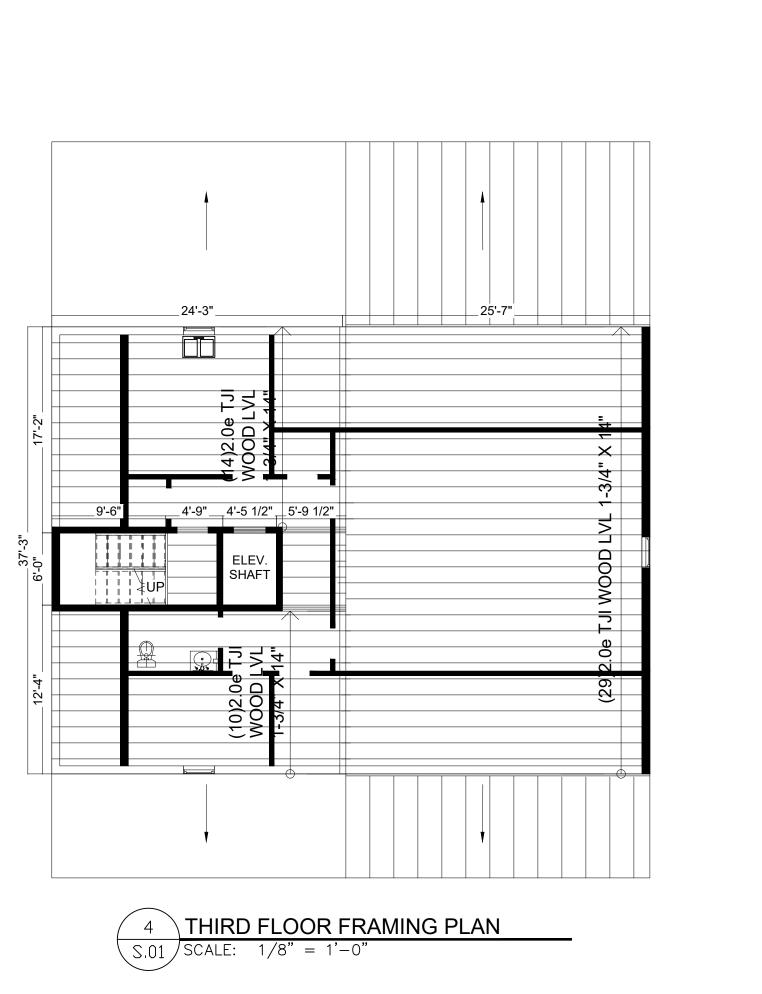

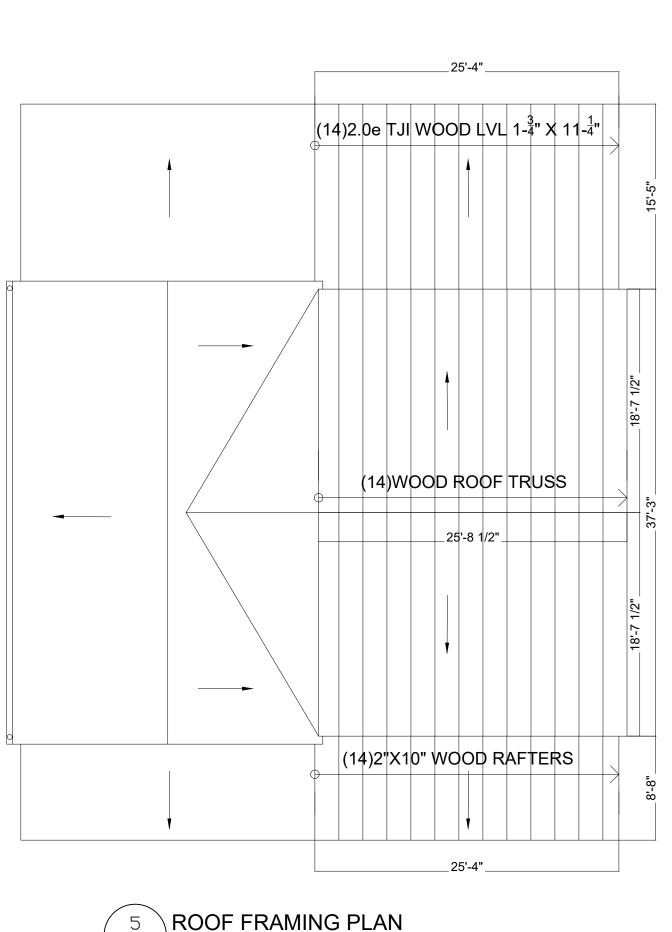

General Notes



GENERAL CONDITIONS

A. THE STANDARD GENERAL CONDITIONS FOR THE CONSTRUCTION CONTRACT N.S.P.E. DOCUMENT 1910-8 SHALL GOVERN THIS WORK AS IF ENTIRELY INCLUDED ON THESE DRAWINGS.



DESIGN LOADS

- A. THE STRUCTURE WAS DESIGNED FOR THE LIVE LOADS SHOWN BELOW AND DEAD LOADS AS REQUIRED BY CONSTRUCTION IN ACCORDANCE WITH IRC 2018.

 INCREASE IN THESE LOADINGS, DUE TO CHANGE IN FUNCTION,
 CONSTRUCTION MATERIALS, ETC. TO HAVE WRITTEN APPROVAL FROM THE DESIGNING STRUCTURAL ENGINEER.
- B. LIVE LOADS SHOWN BELOW ARE IN POUNDS PER SQUARE FOOT.

 ROOF LIVE LOAD: 3Ø GROUND SNOW LOAD (PG): 25

 FLOOR LIVE LOAD: 5Ø SNOW LOAD IMPORTANCE FACTOR: 1.Ø

 WIND CRITERIA:

 BASIC WIND SPEED: 9Ø MPH (3 SECOND GUST)

 WIND IMPORTANCE FACTOR (IW): 1.Ø , BUILDING CATEGORY: II



EXISTING CONDITIONS

MAIN WIND FORCE SYSTEM EXPOSURE CATEGORY: B

- A. EXPOSE EXISTING FRAMING AND NOTIFY ARCHITECT PRIOR TO INSTALLATION OF NEW FRAMING.
- B. CONTRACTOR MUST FIELD CHECK AND VERIFY DIMENSIONS AND ELEVATIONS OF EXISTING WORK PRIOR TO FABRICATION OF NEW MATERIALS.
- C. RELOCATE EXISTING PLUMBING AND HVAC AS REQUIRED TO ALLOW INSTAL-LATION OF NEW FRAMING.



DEMOLITION

- A. DEMOLITION INCLUDES CONTROLLED DESTRUCTION OF STRUCTURES AND THE REMOVAL AND DISPOSAL OF DEMOLISHED MATERIALS AS SHOWN ON THE DRAWINGS AND INCLUDED IN THESE NOTES.
- B. PERFORM DEMOLITION IN SECTIONS SMALL ENOUGH TO PREVENT DAMAGE OF MATERIALS, FACILITIES OR EMBANKMENTS TO REMAIN IN PLACE.
- C. PROVIDE ADEQUATE SHORING, BRACING AND PROTECTION TO PREVENT MOVEMENT, SETTLEMENT, COLLAPSE OR DAMAGE TO EXISTING MATERIALS, FACILITIES OR EMBANKMENTS TO REMAIN.
- D. PROMPTLY REPAIR DAMAGES CAUSED BY THE DEMOLITION TO ADJACENT FACILITIES, MATERIALS OR EMBANKMENTS AT NO COST TO THE OWNER.
- E. PROMPTLY REMOVE FROM SITE AND PROPERLY DISPOSE OF DEBRIS, RUBBISH AND OTHER MATERIALS RESULTING FROM THE DEMOLITION.

2.2

UNDERPINNING

- A. UNDERPINNING SHALL BE WIDTH NOTED AND SHALL BE POURED CONCRETE. SEE CONCRETE NOTES FOR MATERIALS.
- B. INSTALL UNDERPINNING IN LENGTHS SMALL ENOUGH AND SPACED FAR ENOUGH APART TO PREVENT DAMAGE TO THE SUPERSTRUCTURE. TAKE CARE TO ENSURE AGAINST LOSS OF EARTH BEHIND THE WALL. EXCAVATE NO UNDERPINNING SEGMENTS LONGER THAN 4'-Ø" (UNO) AND NO TWO SEGMENTS CLOSER THAN TWELVE FEET CLEAR FROM ONE ANOTHER. IT IS SOLELY THE CONTRACTORS RESPONSIBILITY TO SEE THAT THE UNDERPINNING IS DONE PROPERLY AND THAT SUCH UNDERPINNING WILL NOT DAMAGE OR ENDANGER THE SUPERSTRUCTURE OF THIS OR ADJOINING BUILDINGS.
- C. KEY UNDERPINNING SEGMENTS TOGETHER WITHIN A MINIMUM OF ONE TWO-BY-FOUR INCH VERTICAL KEY AT EVERY JOINT.
- D. CONTRACTOR IS RESPONSIBLE FOR EXISTING WORK AND SHALL REPAIR OR
 REPLACE TO ITS PRESENT CONDITION ANY DAMAGE OR INJURY CAUSED DURING
 UNDERPINNING AT NO CHANGE IN THE CONTRACT PRICE.
- E. PROVIDE NECESSARY TEMPORARY SHORING DURING THE UNDERPINNING OPERATIONS TO PREVENT DAMAGE TO ADJACENT WORK.
- F. PRIOR TO POURING CONCRETE, OWNER SHALL EMPLOY A PROFESSIONAL GEOTECHNICAL ENGINEER (REGISTERED IN THE STATE OF MARYLAND)
 TO VERIFY THAT SOIL BEARING CAPACITY MEETS THAT SPECIFIED IN THE GENERAL NOTES.
- G. LAP HORIZONTAL REBAR TO KEY UNDERPINNING SEGMENTS TOGETHER.

 REBAR FOR LAPS TO BE 3'-Ø" LONG AND TO BE DRIVEN INTO EARTH

 OF NEXT EXCAVATION 1'-6" EACH SIDE.



FOUNDATIONS

- A. A SOIL BEARING CAPACITY OF 3,000 PSF WAS USED FOR FOOTING DESIGN.
 ENGAGE THE SERVICES OF A GEOTECHNICAL ENGINEER TO VERIFY
 EXCAVATIONS AND SOIL BEARING CAPACITY. IF SOIL OF THIS CAPACITY
 IS NOT ENCOUNTERED AT ELEVATIONS INDICATED, CONTACT ENGINEER OF
 RECORD (EOR).
- B. COMPACT FILL AND BACKFILL TO 95% OF ASTM D-696. PERFORM
 FILL AND BACKFILL OPERATIONS UNDER THE DIRECT SUPERVISION OF THE
 GEOTECHNICAL ENGINEER.
- C. PRIOR TO POURING CONCRETE, ENGAGE THE SERVICES OF A PROFESSIONAL GEOTECHNICAL ENGINEER (REGISTERED IN THE JURISDICTION WHERE THE PROJECT IS LOCATED), TO PERFORM TESTS, BORINGS, ETC., REQUIRED TO CERTIFY THAT THE SOIL BEARING CAPACITY MEETS OR EXCEEDS THAT SHOWN IN THE GENERAL NOTES ABOVE. GEOTECHNICAL ENGINEER SHALL VERIFY SUBGRADE CAPACITIES PRIOR TO INSTALLATION OF DRAINAGE FILL AND MOISTURE BARRIER.

$\langle 3.1 \rangle$

CONCRETE

- A. UNLESS GOVERNED BY BUILDING CODE OR LOCAL AMENDMENTS:

 CONCRETE WORK INCLUDING FORMING, MIXING, PLACING, AND CURING SHALL


 BE IN ACCORDANCE WITH ACI 301. PLACEMENT OF REINFORCING SHALL BE


 IN ACCORDANCE WITH ACI 315 AND 318. WHEN THERE IS A CONFLICT, THE

 MOST STRINGENT IS TO APPLY.
- B. CONCRETE REINFORCING: A.S.T.M. A-615, GRADE 60.
- C. WELDED WIRE MESH: A.S.T.M. A-185.
- D. PORTLAND CEMENT: A.S.T.M. C-150, TYPE I.
- E. BLENDED HYDRAULIC CEMENT: A.S.T.M. C-595.
- F. FLY ASH: A.S.T.M. C-618, CLASS F (25% MAX.)(
- G. AGGREGATE: A.S.T.M. C-33. 1" MAXIMUM FOR FOOTINGS, WALLS AND SLABS
 ON GRADE, 1/2" MAXIMUM FOR THIN SLABS AND 3/8" FOR WALL FILL
- H. CONCRETE SHALL HAVE A 28 DAY COMPRESSIVE STRENGTH OF: 3,000 PSI.
- I. WATER CEMENT RATIO NOT TO EXCEED .54 FOR 3,000 PSI CONCRETE.
- J. INSTALL WELDED WIRE MESH 2" BELOW UPPER SURFACE OF CONCRETE SLAB.
- K. REINFORCING FOR FOOTINGS AND OTHER CONCRETE USING EARTH FORMS SHALL HAVE 3" CONCRETE COVER. REINFORCING FOR CONCRETE EXPOSED TO GROUND OR WEATHER AFTER REMOVAL OF FORMS SHALL HAVE 2" CONCRETE COVER. REINFORCING SHALL HAVE 3/4" CONCRETE COVER FOR SLABS AND WALLS AND 1 1/2" COVER FOR BEAMS, GIRDERS & COLUMNS.
- L. LAP CONTINUOUS FOOTING REINFORCING 44 BAR DIAMETERS AT SPLICES.
- M. USE A WATER REDUCING ADMIXTURE IN ALL CONCRETE.
- N. USE A MINIMUM OF 5 1/2 BAGS OF CEMENT AND A MAXIMUM OF 6 1/2 GALLONS
 OF WATER PER BAG FOR EACH CUBIC YARD OF CONCRETE.
- O. SLUMP AS REQUIRED BY ACI (211.1) EXCEPT THAT SLABS ON GRADE AND THIN FRAMED SLABS SHALL HAVE A MAXIMUM SLUMP OF 4". SHOULD EXTRA WATER BE REQUIRED BEFORE DEPOSITING CONCRETE AND WATER/CEMENT RATIO OF ACCEPTED MIX DESIGN HAS NOT BEEN EXCEEDED, GENERAL CONTRACTOR'S SUPERINTENDENT SHALL HAVE SOLE AUTHORITY TO AUTHORIZE ADDITION OF WATER. ANY ADDITIONAL WATER ADDED TO MIX AFTER LEAVING BATCH PLANT SHALL BE INDICATED ON THE TRUCK TICKET AND SIGNED BY PERSON RESPONSIBLE. SUBMIT COPY OF TRUCK TICKET FOR REVIEW.
- P. NO CALCIUM CHLORIDE WILL BE PERMITTED IN CONCRETE.


SYMBOLS


A. ALL TYPICAL DETAILS, SECTIONS, AND NOTES ARE GENERAL IN NATURE
AND USAGE IS NOT LIMITED TO WHERE SPECIFICALLY NOTED.

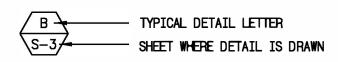

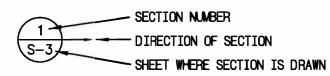




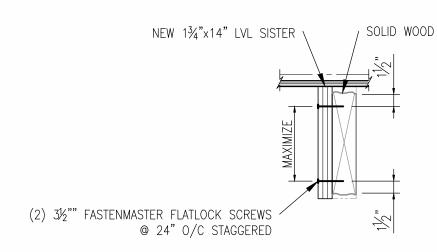


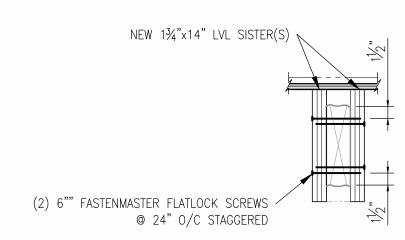

EXISTING FLOOR JOIST W/ >10%, <50% DETERIORATION

EXISTING FLOOR JOIST W/ >50% DETERIORATION

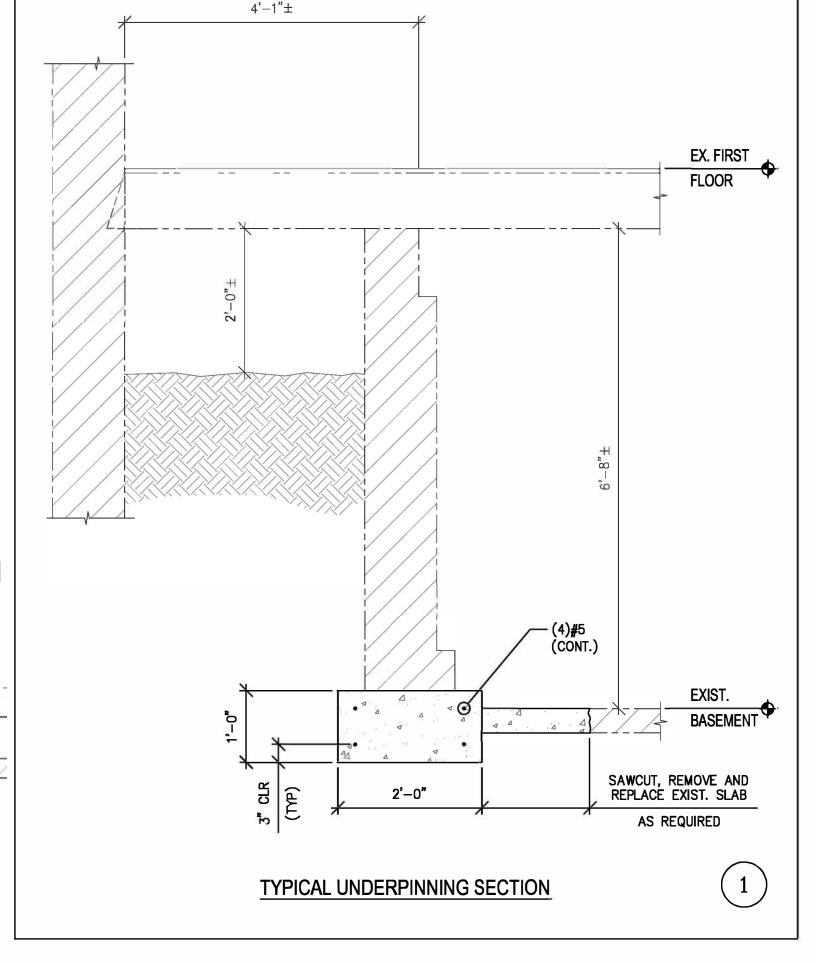

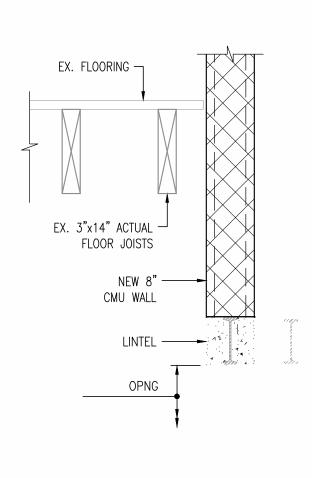

TYPICAL LINTEL SECTION
SCALE: 3/4" = 1'-0"

STEEL-LINTELS

1. ALL STEEL LINTELS IN MASONRY WALLS SHALL BE AS NOTED BELOW WITH SIZES AS FOLLOWS FOR EACH 4" OF WALL THICKNESS OR FRACTION THEREOF (UNLESS NOTED OTHERWISE ON DRAWINGS):

<u>SPAN</u> UNDER 6'-0"

END BEARING ANGLE SIZE

UNDER 6'-0" 8" 4" X 3-1/2" X 5/16"

2. PROVIDE 100% SOLID MASONRY BELOW ALL LINTEL BEARINGS 8" BEYOND THE OPENING FOR THE FULL WALL WIDTH AT ALL LINTELS FROM THE LINTEL BEARING TO THE FLOOR BELOW.

3. ALL LINTELS TO BE SET TRUE AND LEVEL.

Foundation / Underpinning / Lintel

UNDERPINNING SEGMENTS ARE TO BE IN 4'-0" (MAX) WIDTHS (UNO). PROVIDE ADDITIONAL SEGMENTS AS REQUIRED BY ACTUAL FIELD CONDITIONS. DIMENSIONS SHOWN ARE APPROXIMATE. ALL DIMENSIONS SHALL BE VERIFIED IN THE FIELD.

— SAWCUT, REMOVE AND REPLACE


EXIST, SLAB AS REQ'D

- AREA OF UNDERPINNING

(TYP AS SHOWN)

- 2. PITS IN FIRST SEQUENCE SHALL BE EXCAVATED TO PROPER ELEVATION ALLOWING FOR FULL SPECIFIED FOOTING/UNDERPINNING THICKNESS AND A NOMINAL 1" FOR FINAL GROUTING BETWEEN UNDERPINNING AND EXISTING FOUNDATION.
- 3. PLACE UNDERPINNING WITH A HIGH EARLY STRENGTH CONCRETE MIX HAVING A DESIGNED 28—DAY COMPRESSIVE STRENGTH OF 4,000 PSI. FORMS SHALL NOT BE STRIPPED UNTIL THE UNDERPINNING CONCRETE HAS A STRENGTH OF 75% OF DESIGN STRENGTH.
- 4. REPEAT THE ABOVE PROCEDURE FOR THE REMAINING PIT SEQUENCES. CONCRETE AND GROUT MUST ATTAIN A MINIMUM COMPRESSIVE STRENGTH OF 4,000 PSI PRIOR TO COMMENCING EXCAVATION FOR ANY PITS DIRECTLY ADJACENT TO THE NEW WORK.
- (X) Indicates underpinning segment pour number.
- 6. AFTER INITIAL SECTION '1' EXCAVATIONS AND PRIOR TO UNDERMINING EXCAVATION OF EXISTING FOOTING, AND UNDERPINNING, NOTIFY 'UNDERPINNING STRUCTURAL ENGINEER OF RECORD' OF <u>ANY</u> DISCREPANCIES OF EXISTING CONDITIONS UNCOVERED THAT WOULD OTHERWISE CAUSE A DEVIATION IN THESE PLANS OR DETAILS FOR APPROVAL OF DETERMINING AN ALTERNATIVE COURSE OF ACTION.

25			Underpinning Foundation	DWG. TITLE:	O a read Nate	1 0		DWG. NO.:	
			Orderpinning roundation	General Notes and Section		tion	$\triangle A$		
				JOB NO.;	00000	DRAWN:	NID		
				, ,	22863	2	NJR		
				DATE:		CHECKED:	SMB		

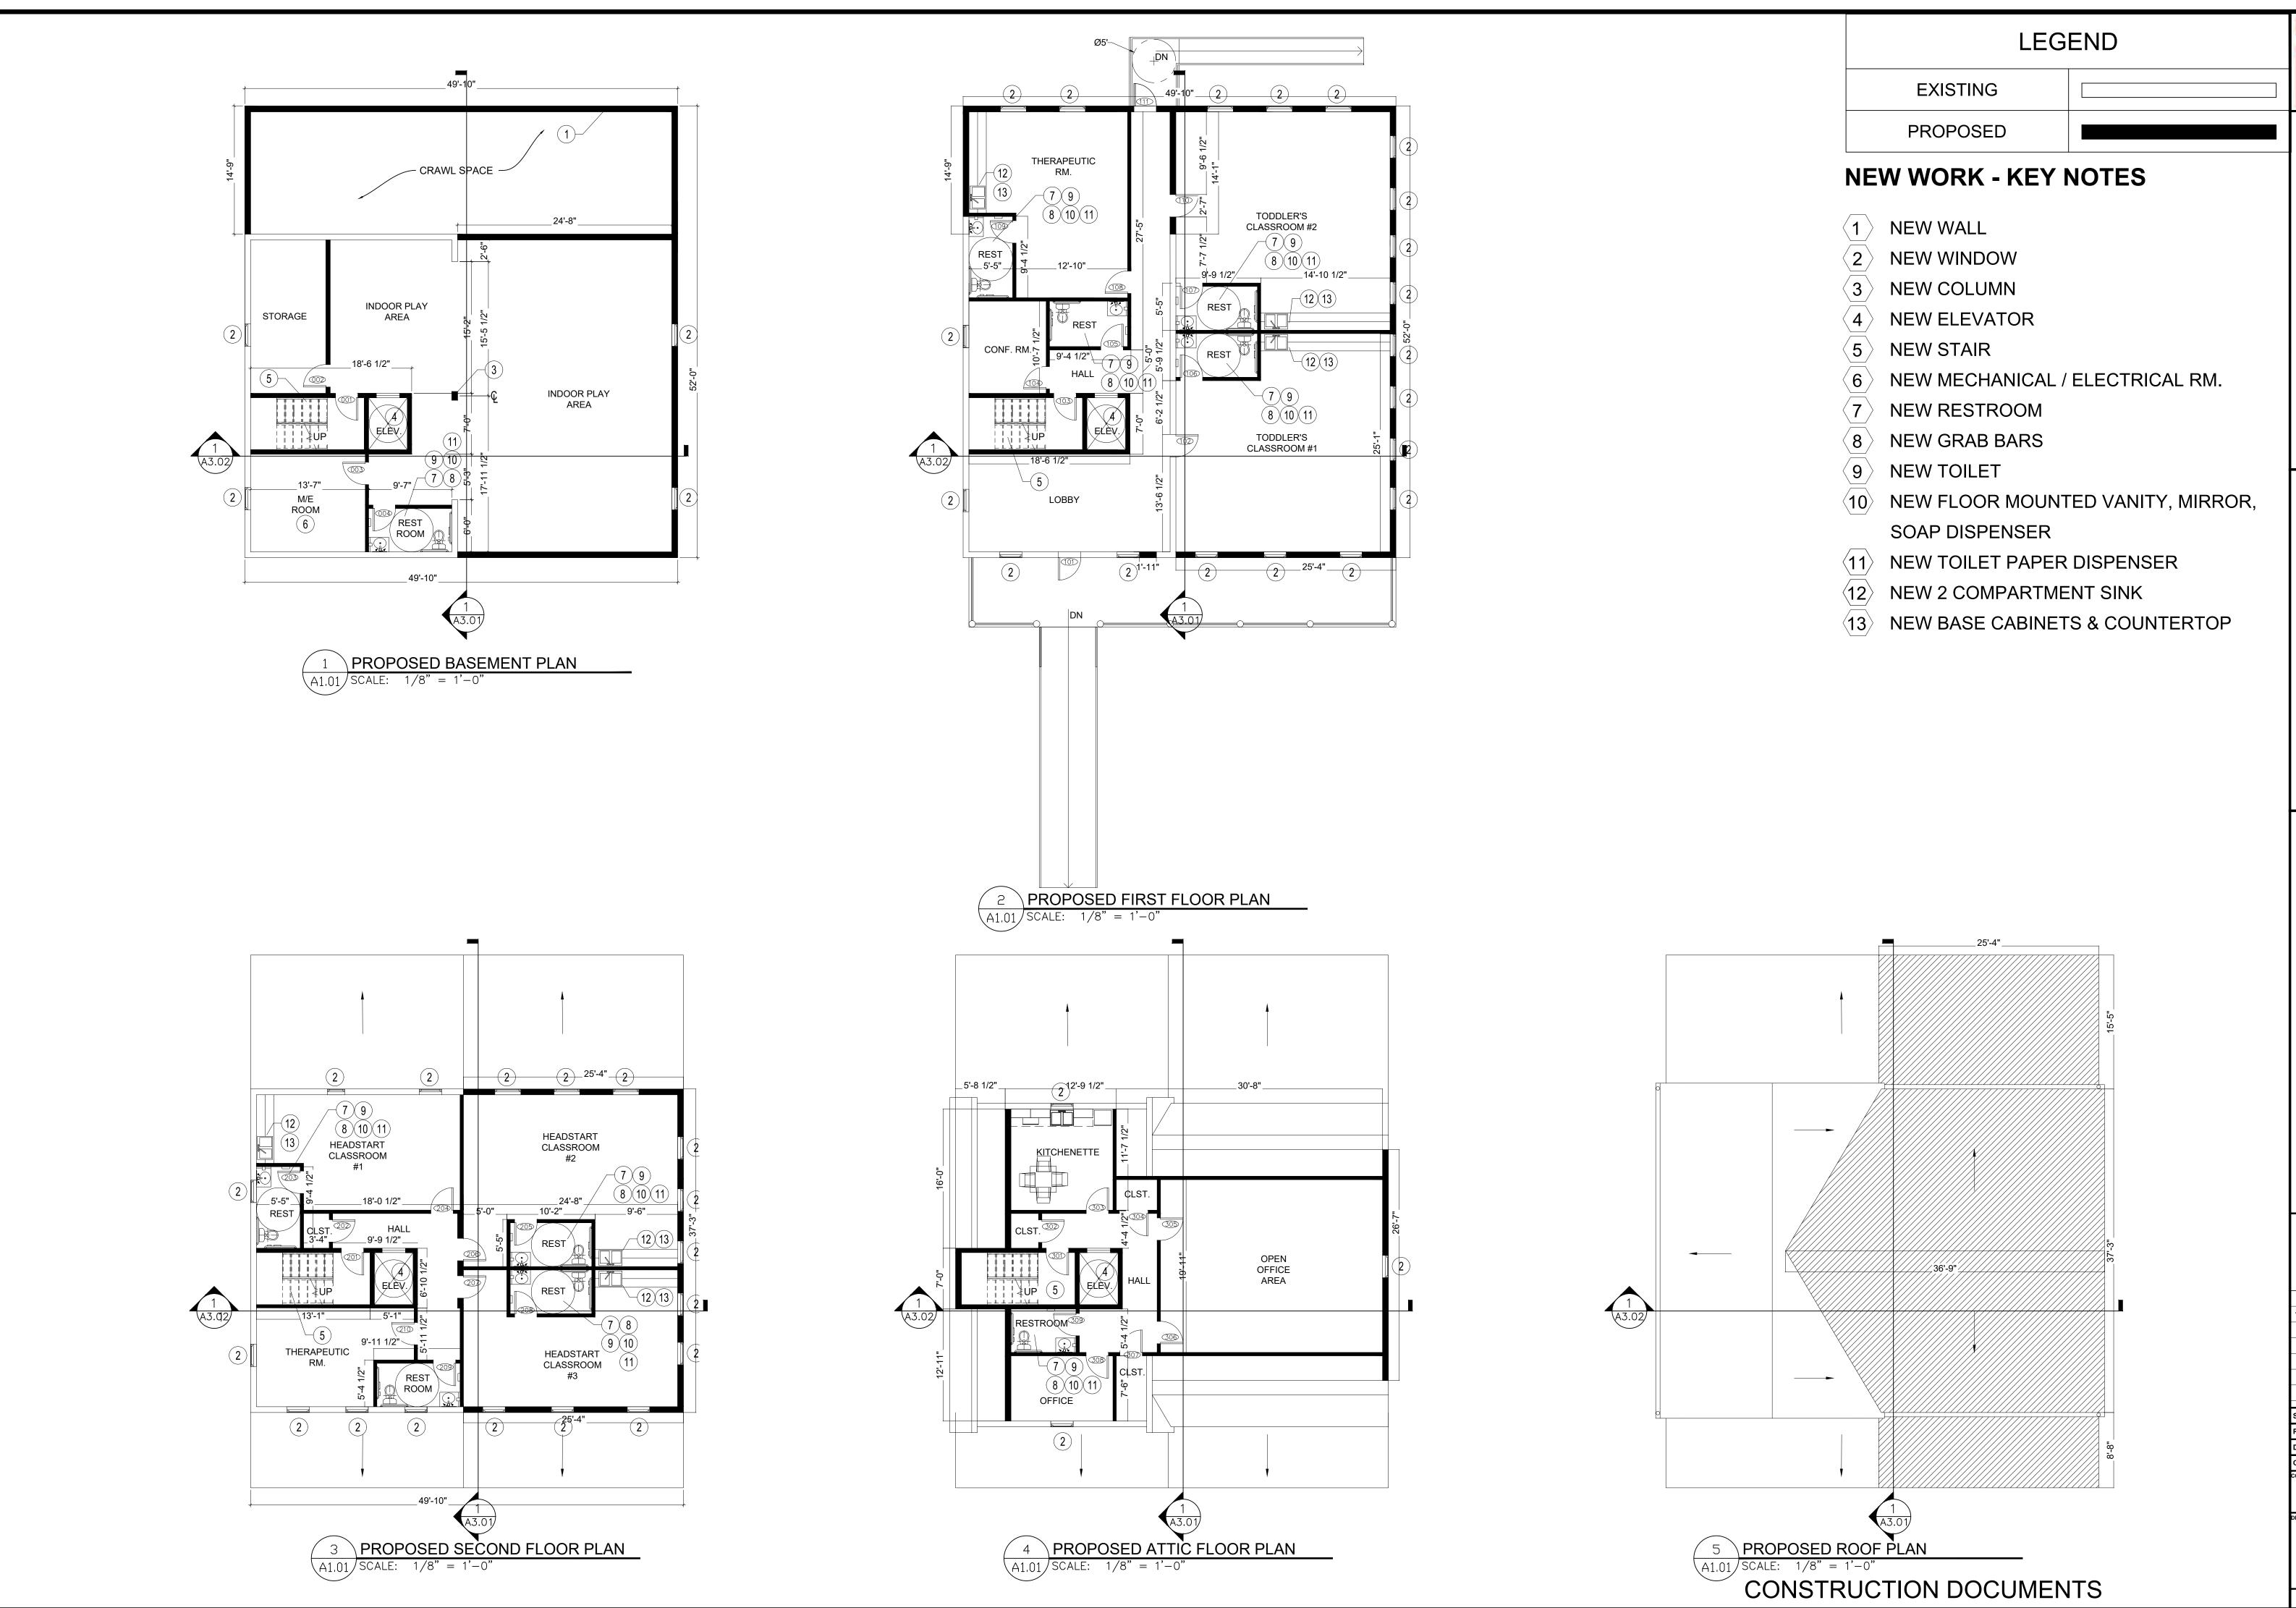

ASSOCIATES, I

SULTON CAMPBELL BRITT & Architecture * Historic Preservation * Plans

1010 EAST 43RD STREET BALTIMORE, MD. 21212

ISSUE DATES
2.27 ORIG. SUB.

SCALE:
PROJECT NO:

DRAWN BY: KMD


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CONTENT

PROPOSED FLOOR
PLANS

A1.0

SHEET <u>6</u> OF <u>32</u>

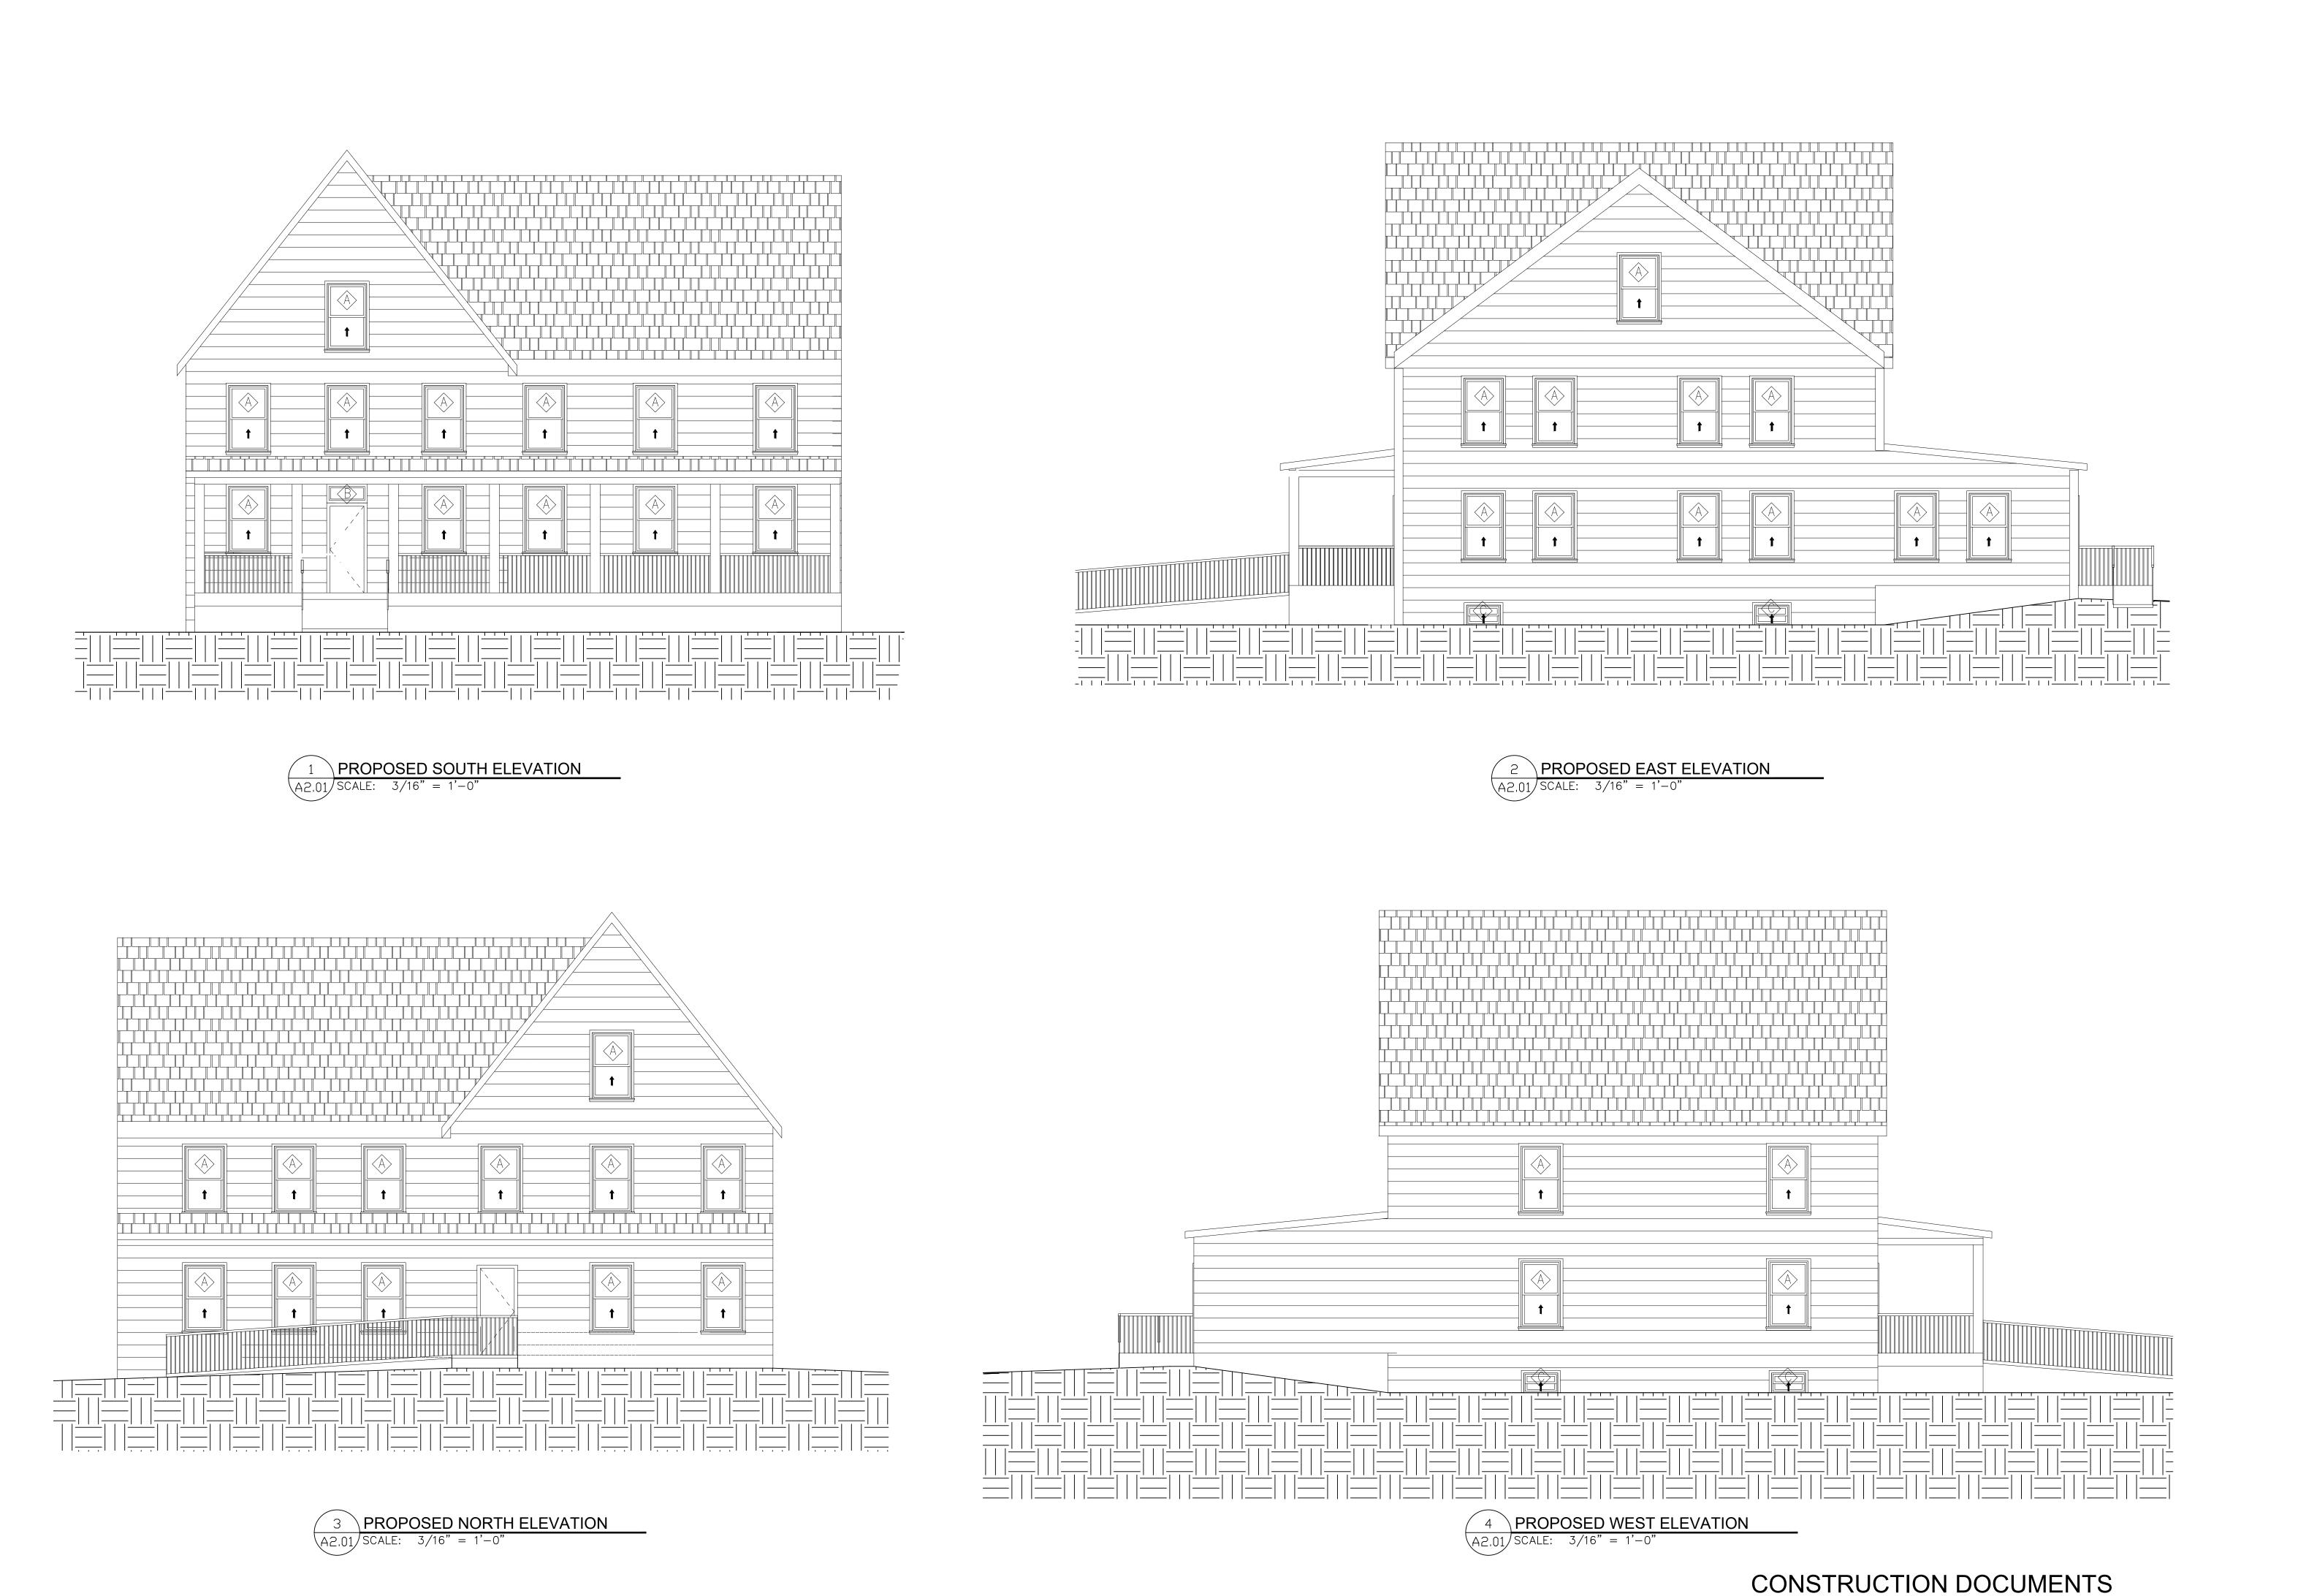

.C.

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ISSUE DATES

2.27 ORIG. SUB.

SCALE:
PROJECT NO:
DRAWN BY: KMD
CHECKED BY: DGG

PROPOSED ELEVATION

WING NO.

SHEET 7 OF 32



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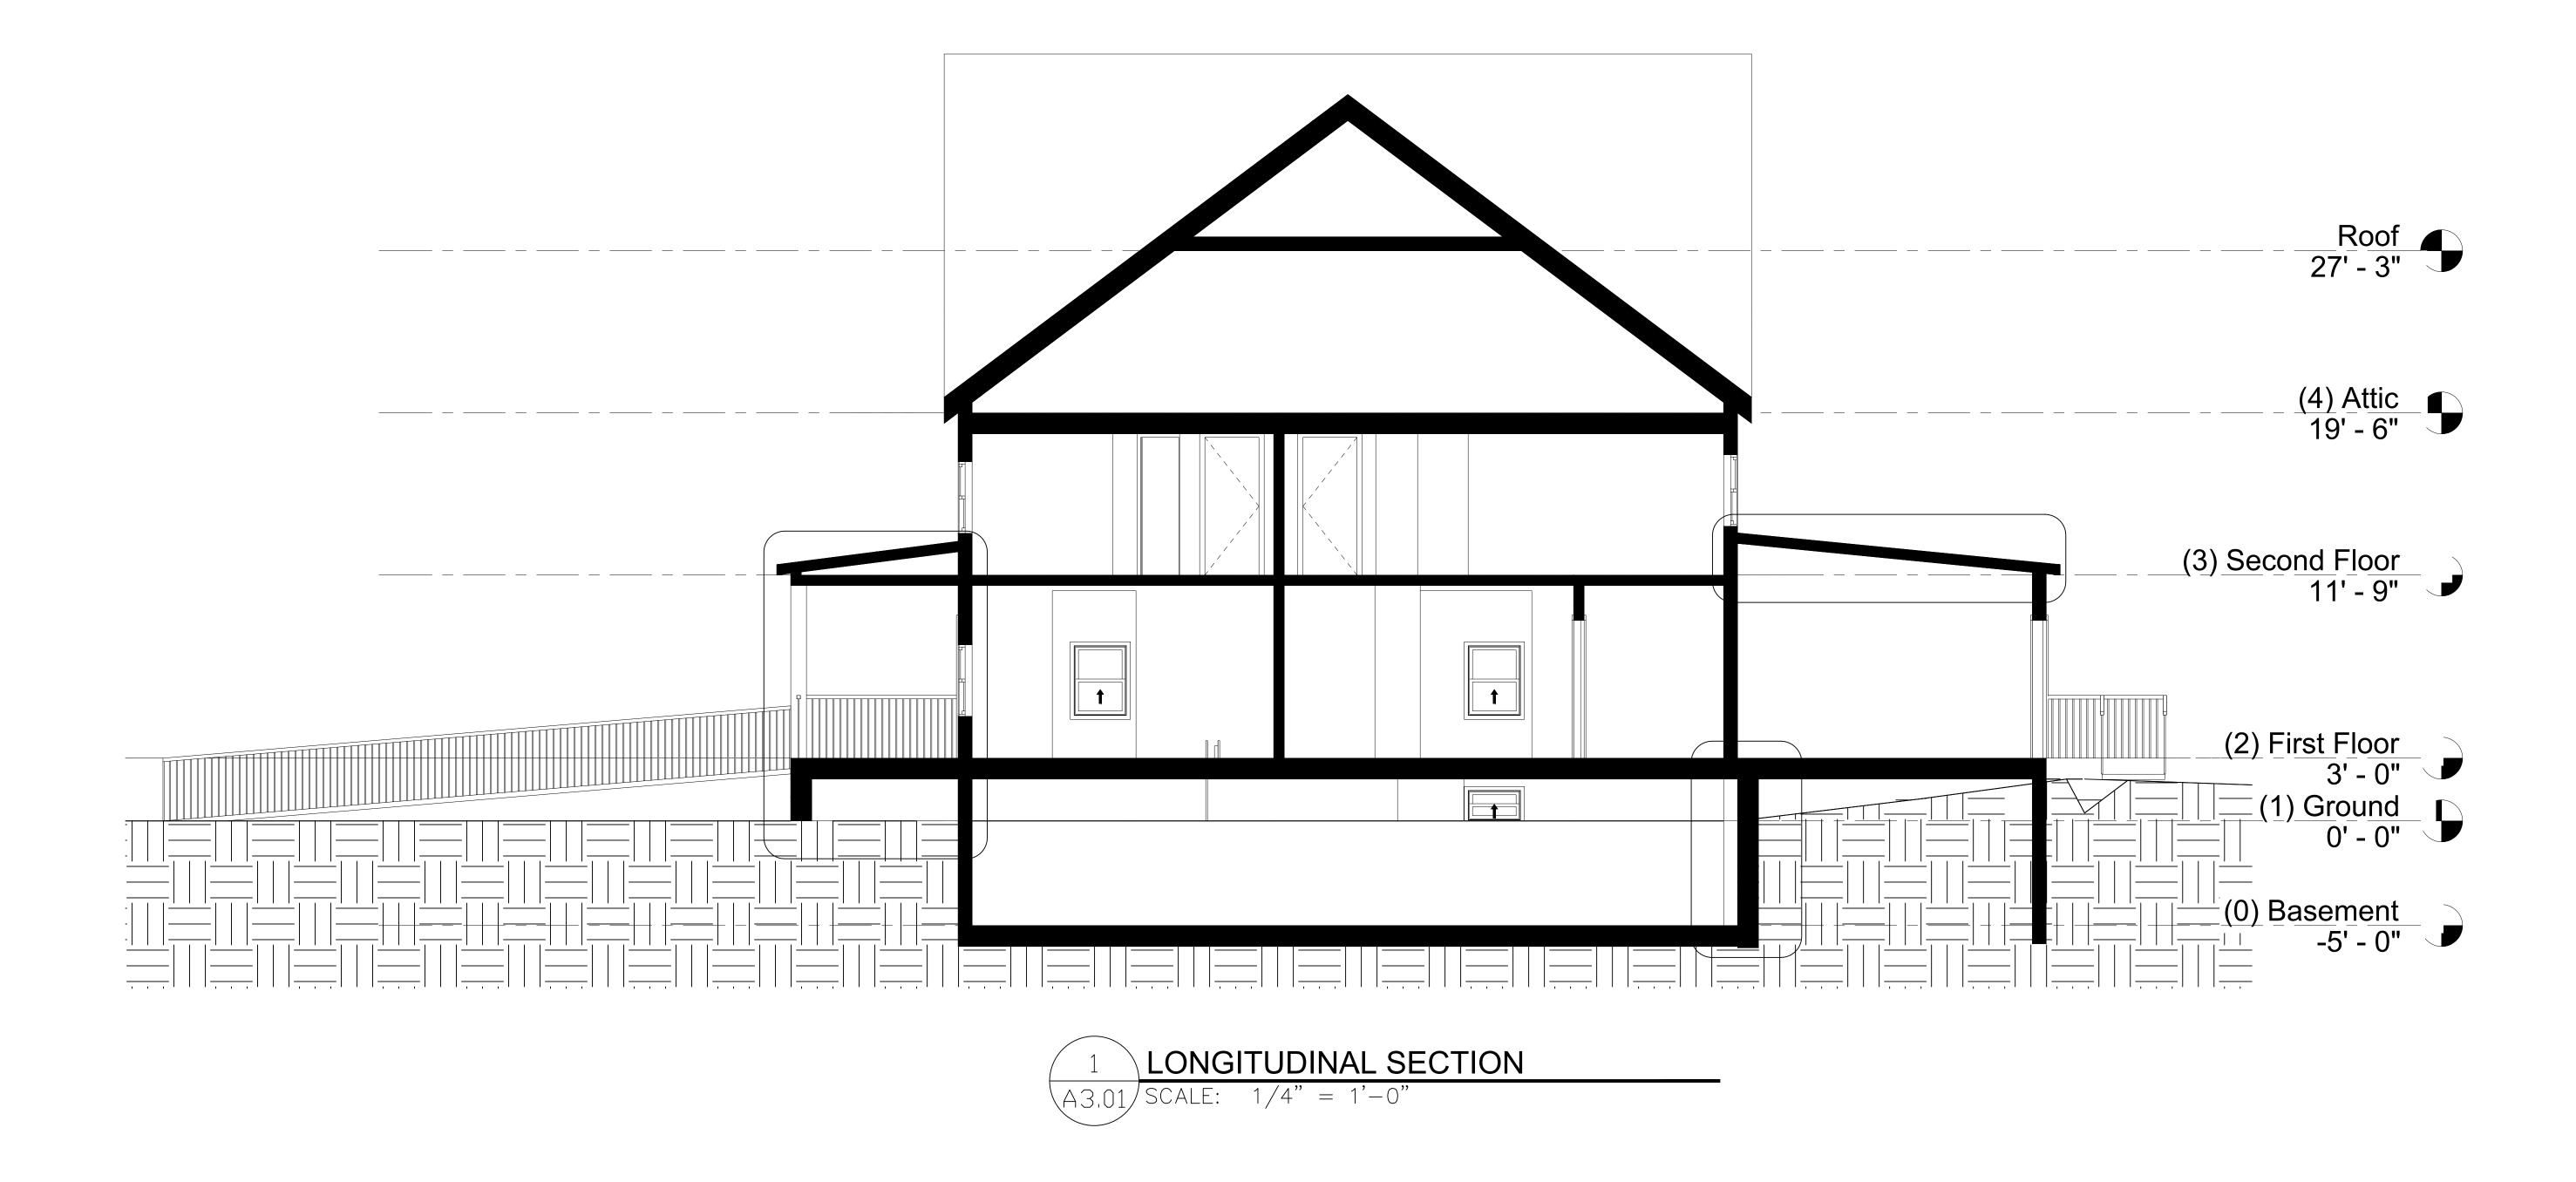
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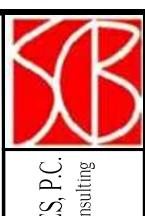
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LONGITUDINAL SECTION

A3.01

SHEET <u>8</u> OF <u>32</u>





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(4) Attic 19' - 6"

(3) Second Floor 11' - 9"

(1) Ground 0' - 0"

(0) Basement -5' - 0"

1 TRANSVERSE SECTION

A3.02 SCALE: 1/4" = 1'-0"

ISSUE DATES

1 2.27 ORIG. SUB.


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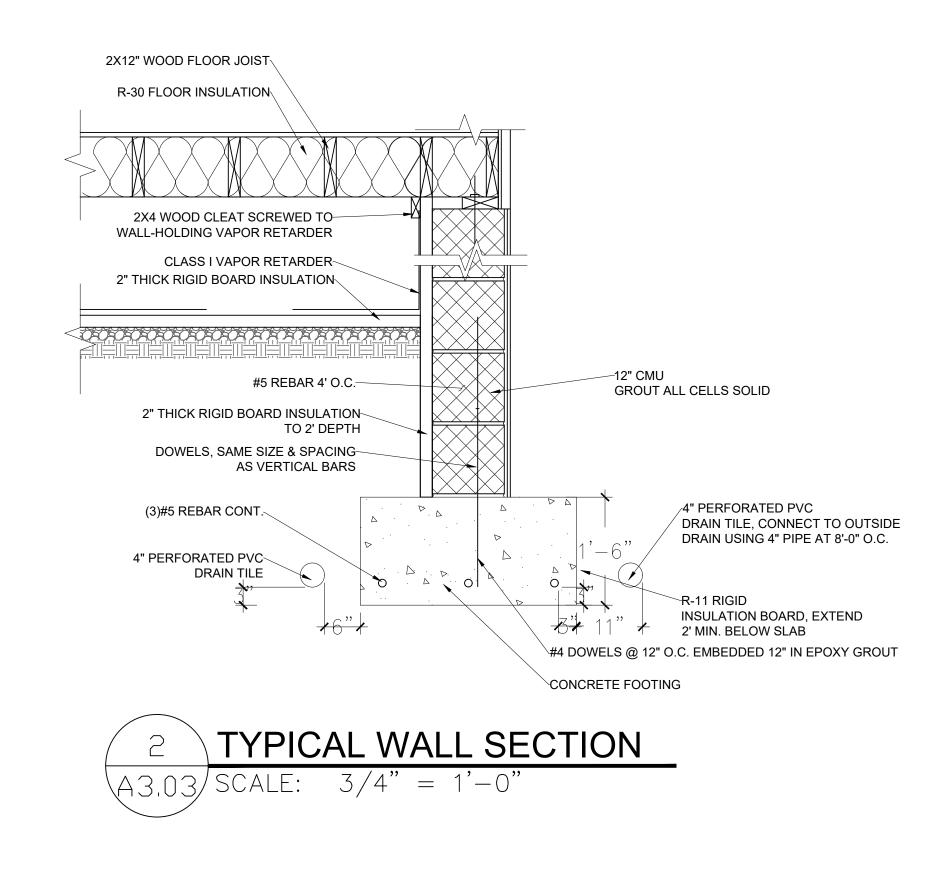
TRANSVERSE SECTION

A3.02

SHEET 9 OF 32

Roof 27' - 3"



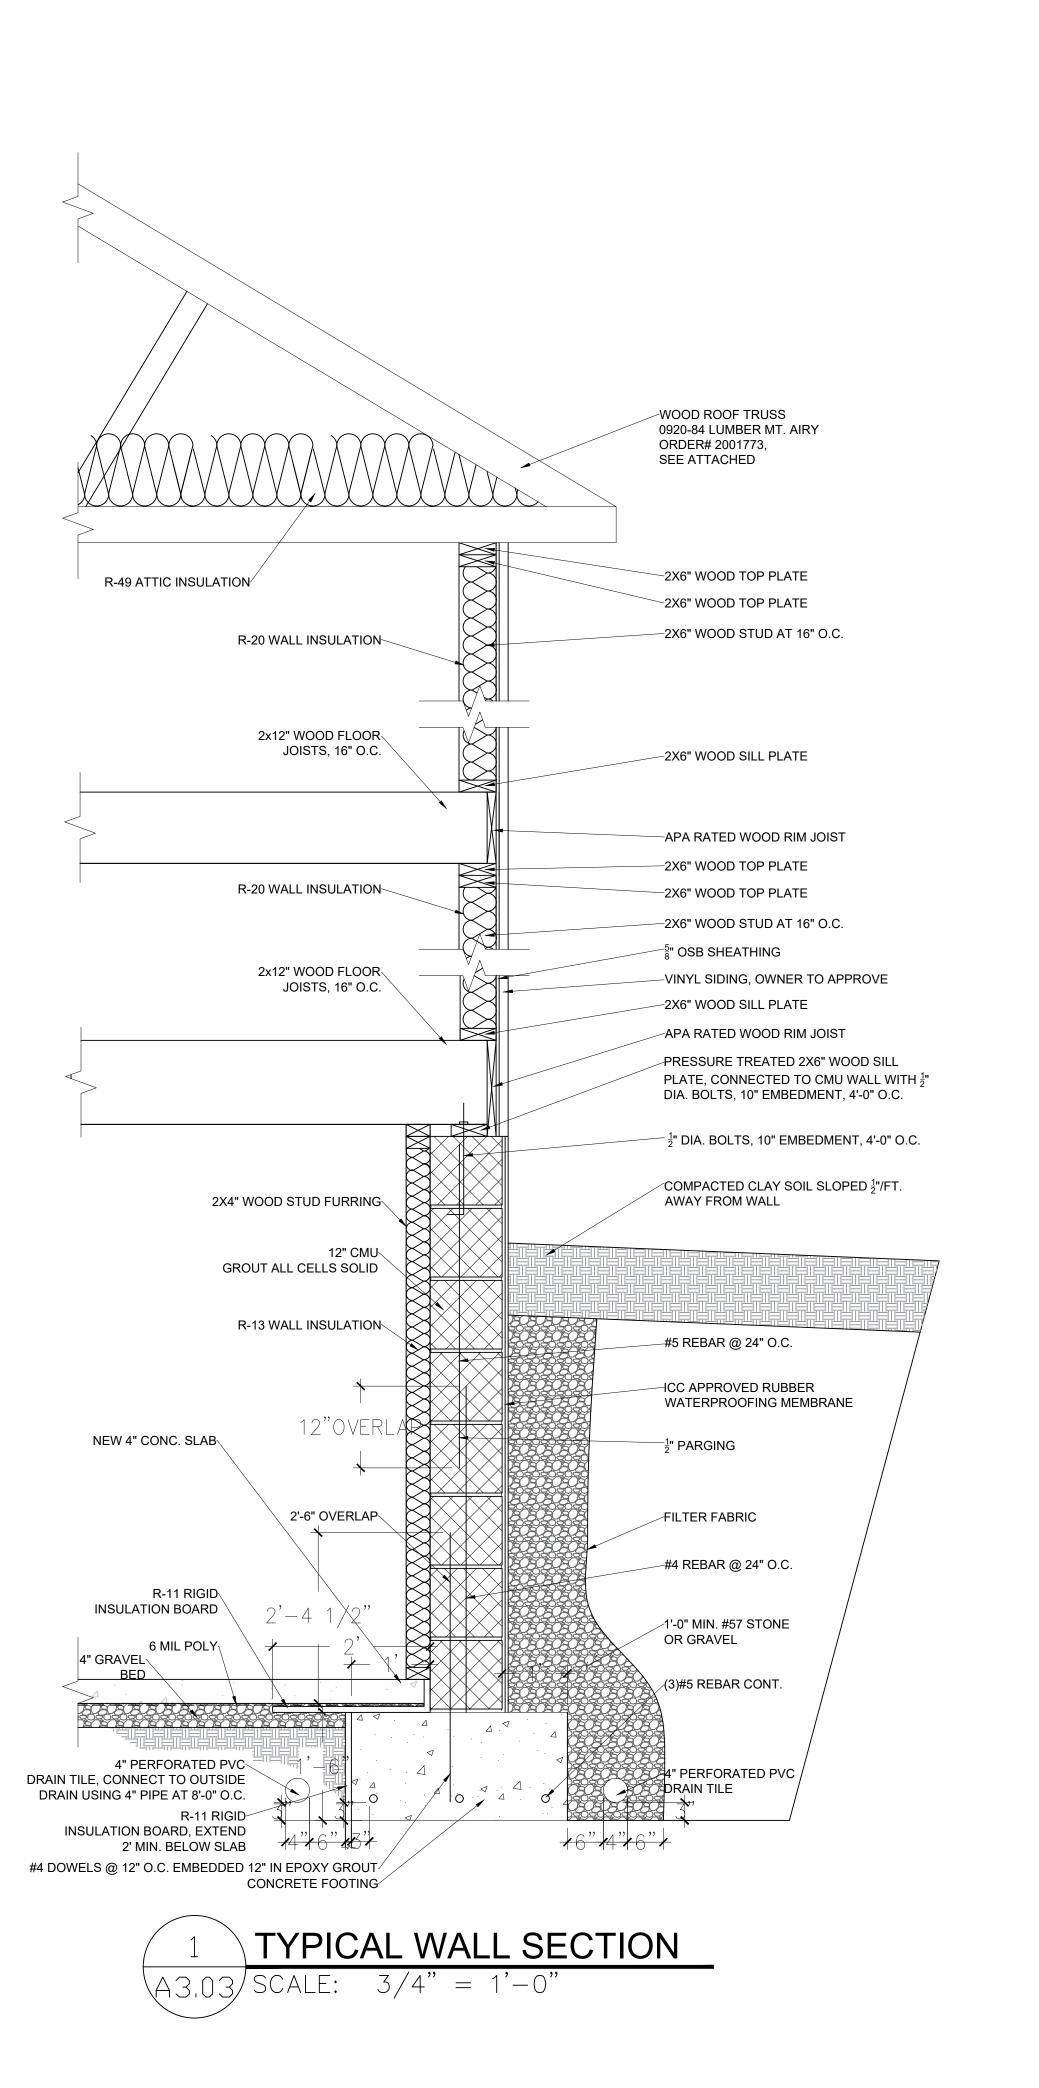

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COMMERCIAL RENOVATION

ISSUE DATES


2.27 ORIG. SUB.

SCALE:
PROJECT NO:
DRAWN BY: KMD

CHECKED BY: DGG
CONTENT
TYPICAL WALL
SECTIONS

A A

SHEET <u>10</u> OF <u>32</u>

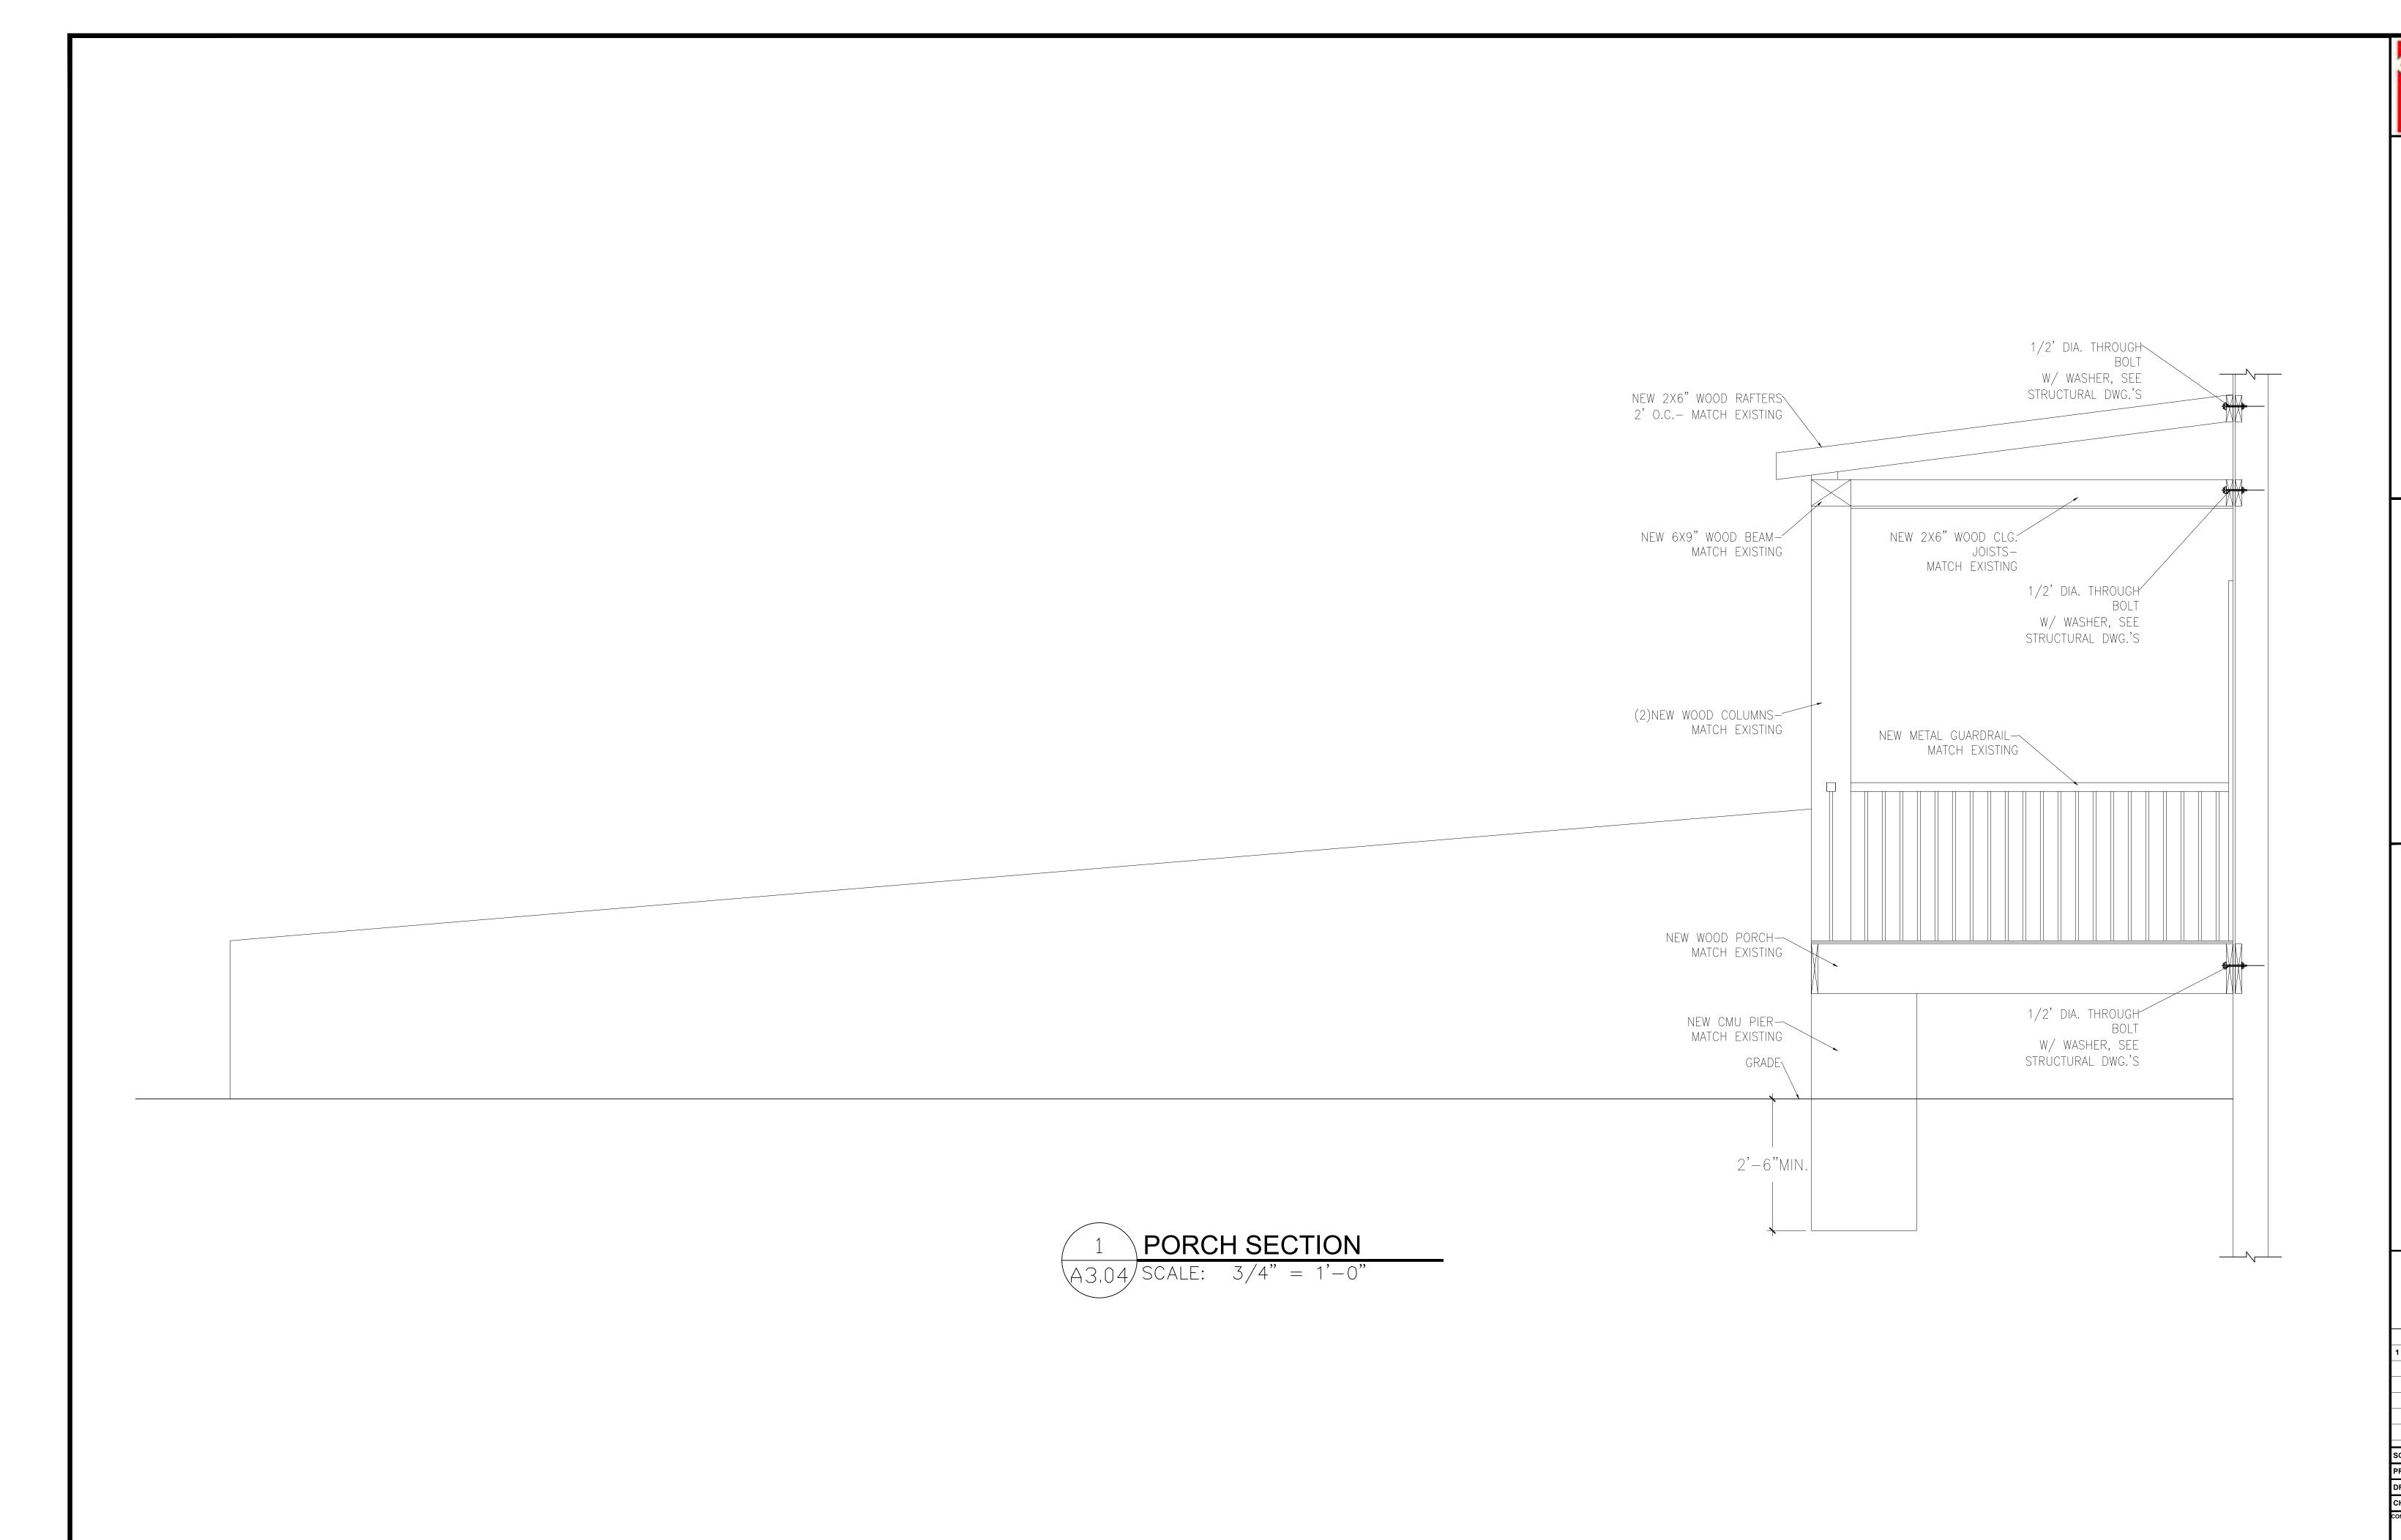

P.C. ting

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ISSUE DATES

2.27 ORIG. SUB.


SCALE:
PROJECT NO:
DRAWN BY: KMD

DRAWN BY: KMD
CHECKED BY: DGG
CONTENT
PORCH
SECTION

G NO.

A3.04

SHEET <u>11</u> OF <u>32</u>

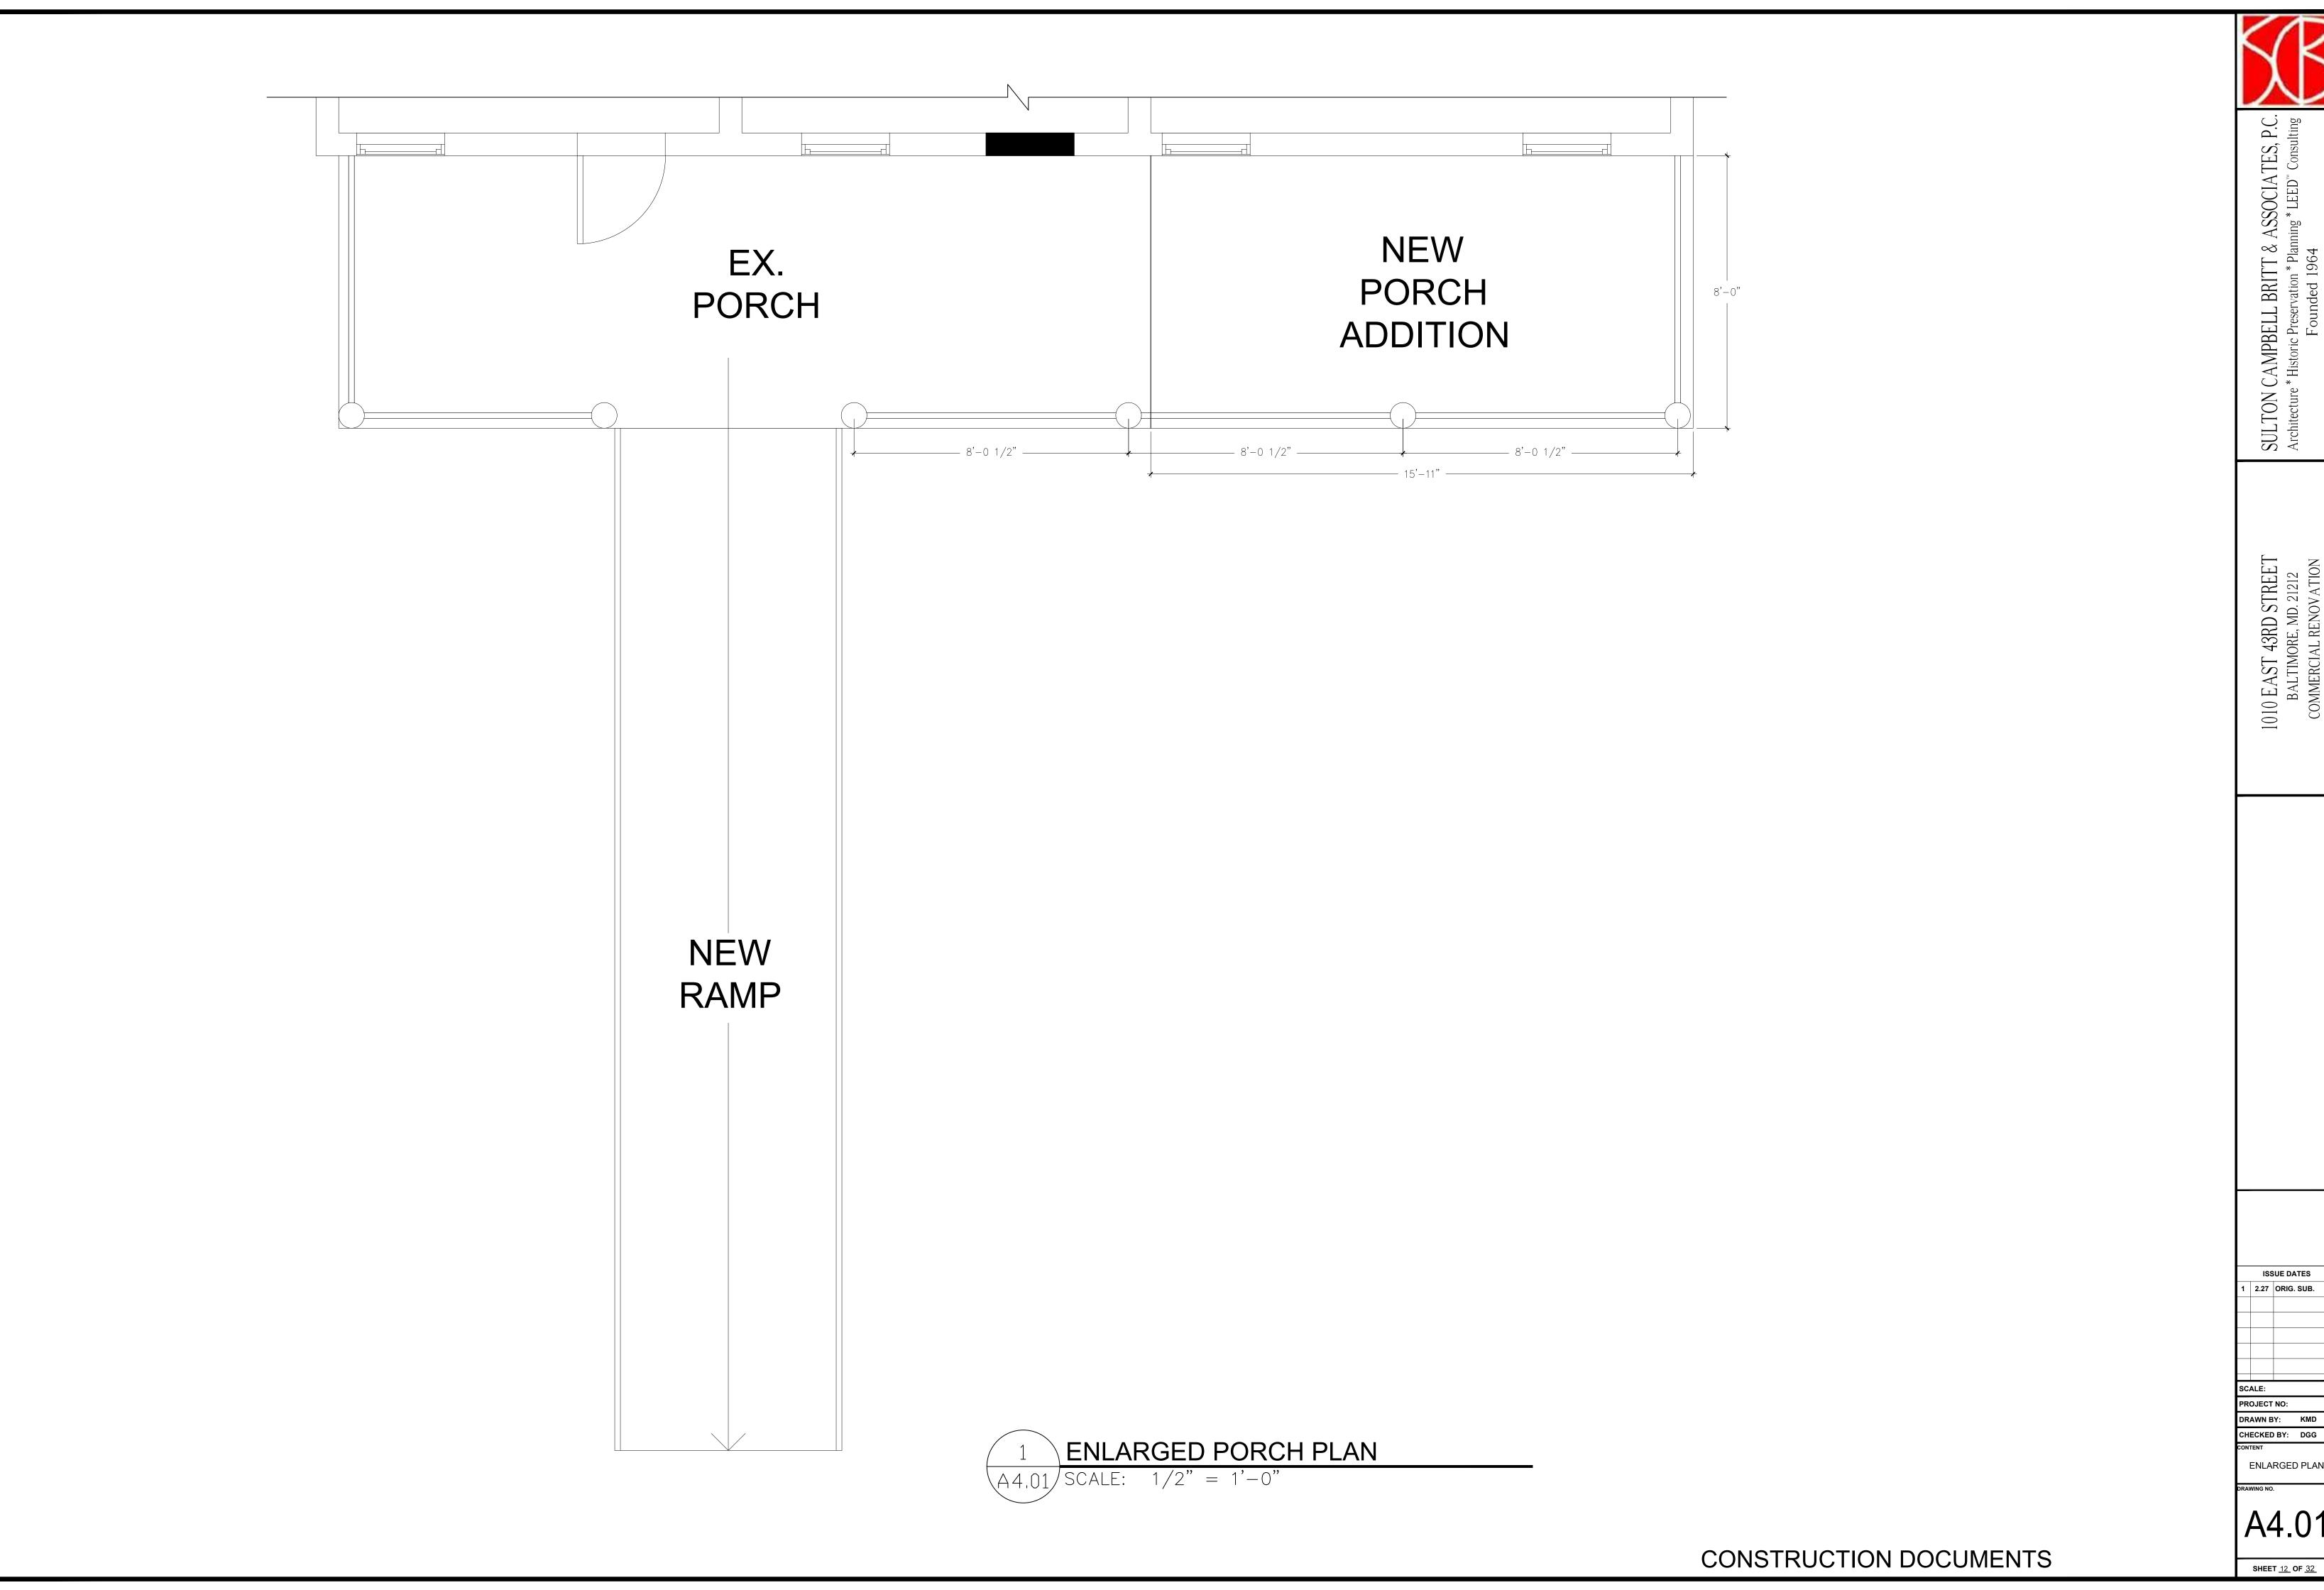

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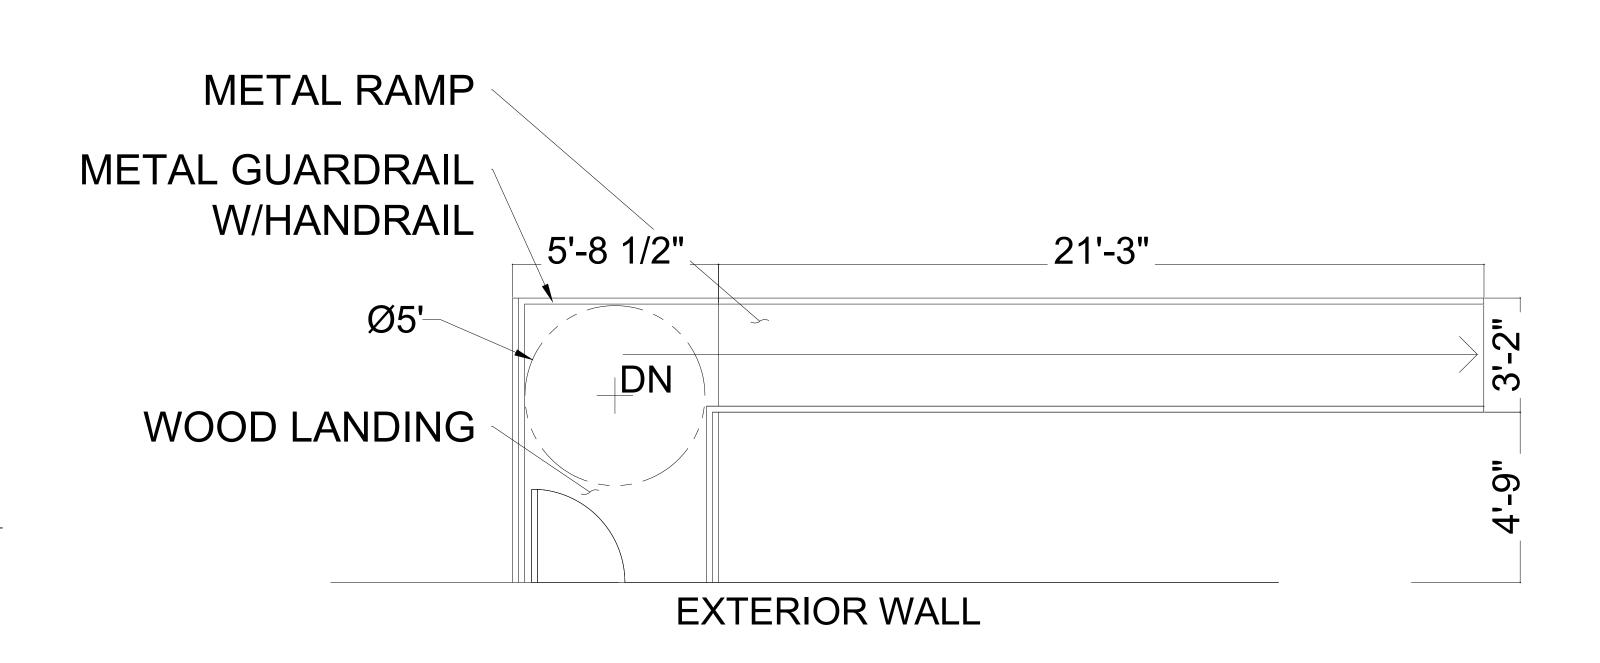
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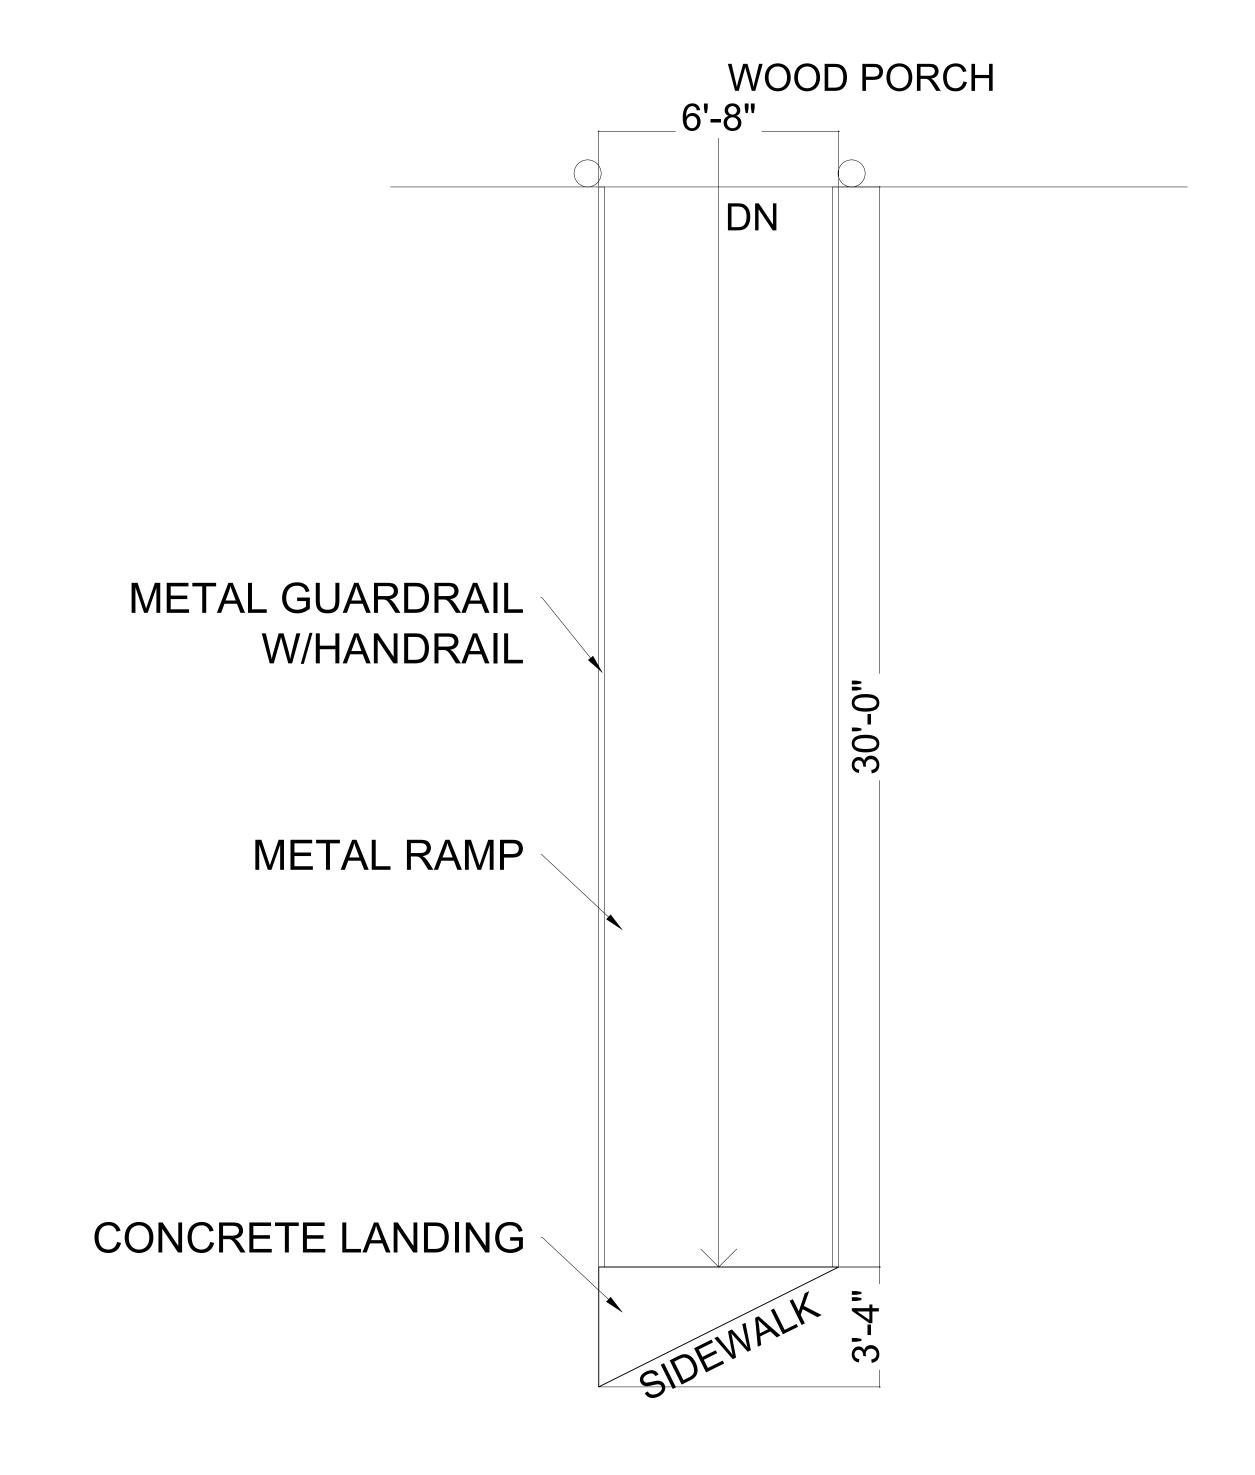
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A4.01









P.C. Iting

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ISSUE DATES


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SCALE:
PROJECT NO:
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A4.02

SHEET <u>13</u> OF <u>32</u>





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ISSUE DATES 2.27 ORIG. SUB.

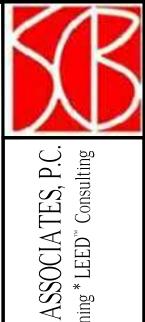PROJECT NO: CHECKED BY: DGG


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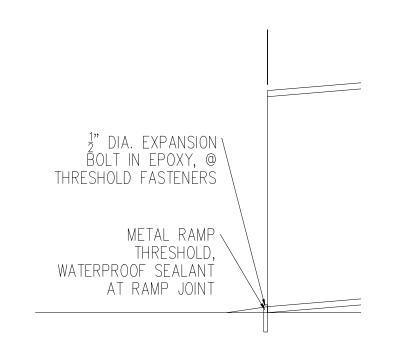
A5.01

SHEET <u>14</u> OF <u>32</u>

CONSTRUCTION DOCUMENTS







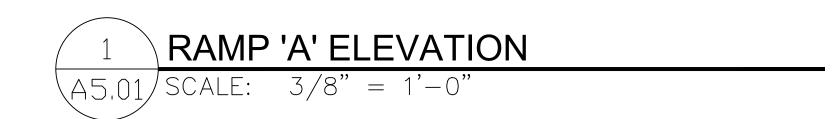



TYPICAL RAMP THRESHOLD

A5.01/SCALE: 3/4" = 1'-0"

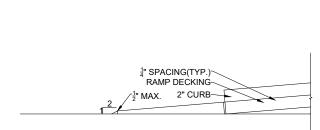

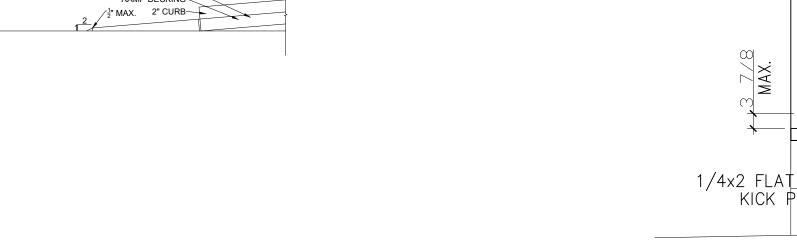

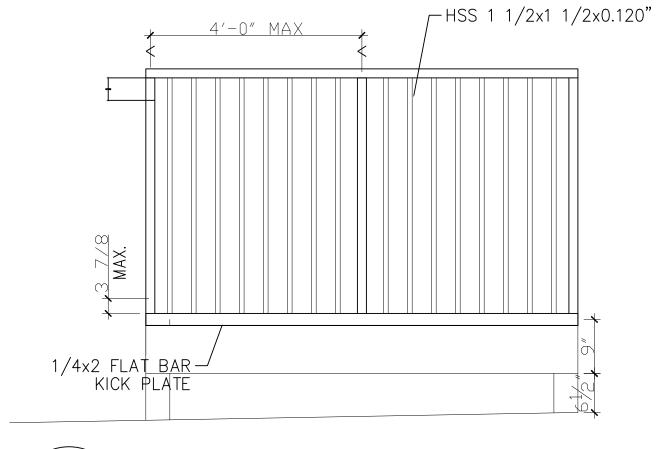

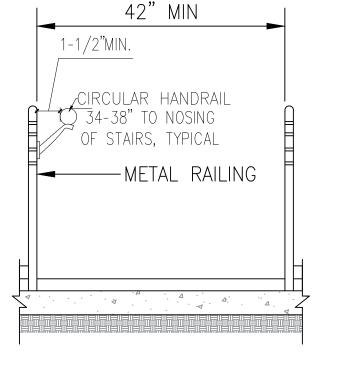








RAMP 'B' ELEVATION

A5.01/SCALE: 3/8" = 1'-0"

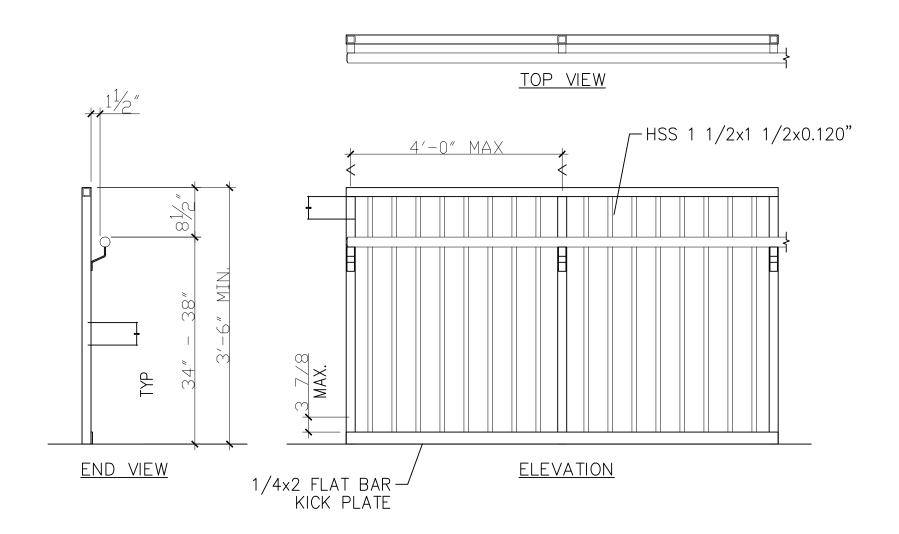



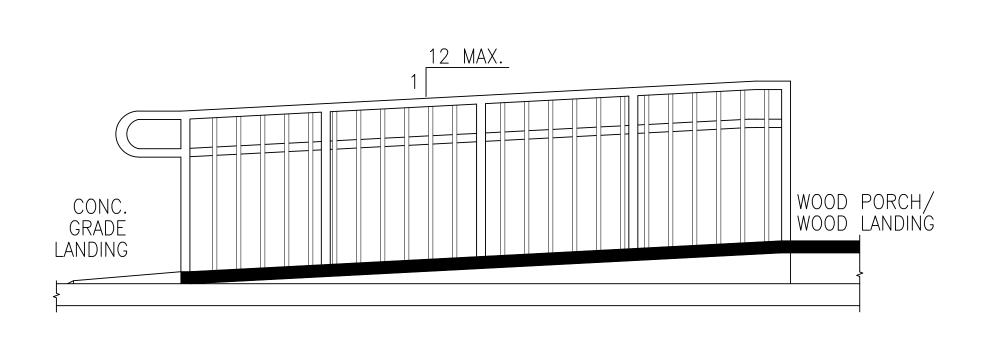

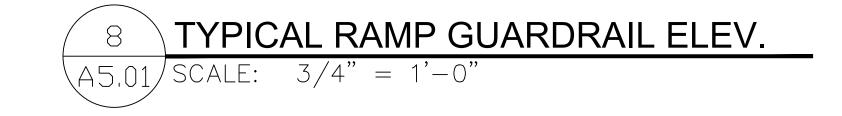

SULTON Architecture

43RD STREET ORE, MD. 21212 1010 EAST


2.27 ORIG. SUB.

PROJECT NO:

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A5.02




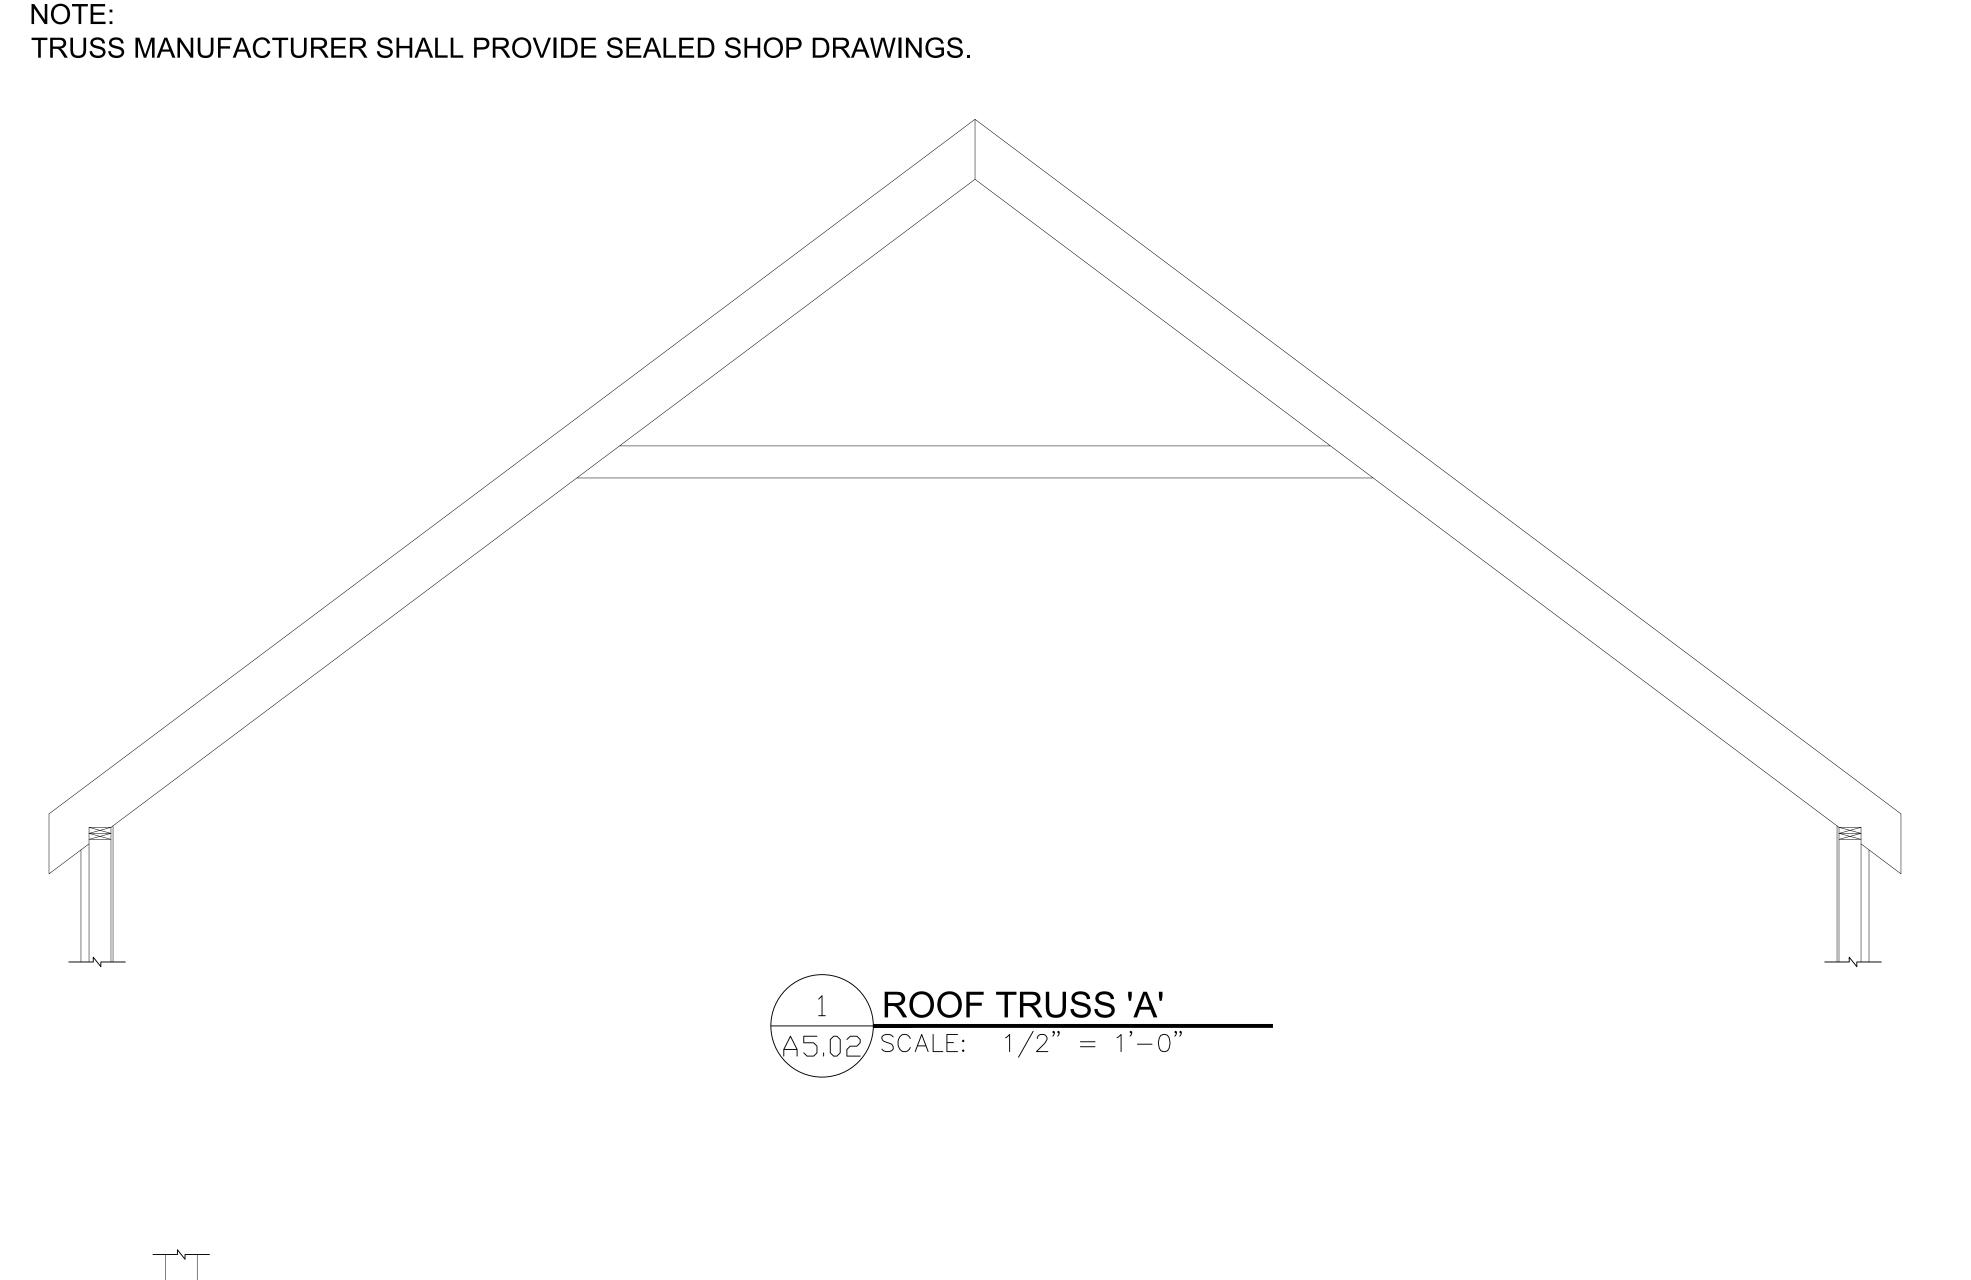

W/ WASHER, SEE

ROOF SECTION 'A'

A5.02/SCALE: 1/2" = 1'-0"

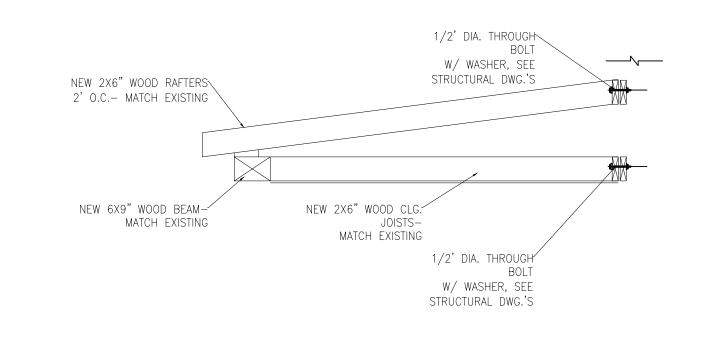



THE TRUSS MANUFACTURER SHALL PROVIDE THE CALCULATIONS & SIZING FOR ALL TRUSS FRAMING MEMBERS, **ALL TRUSS CONNECTIONS &** CONTINUOUS STABILITY AT RIDGE WITH SUPPORT BLOCKING AS NECESSARY

WOOD TRUSS DESIGN DRAWINGS SHALL BE PROVIDED TO THE BUILDING OFFICIAL & APPROVED PRIOR TO INSTALLATION. TRUSS DESIGN DRAWINGS SHALL BE PROVIDED PRIOR TO OR WITH THE SHIPMENT OF TRUSSES DELIVERED TO THE JOB SITE. TRUSS DESIGN DRAWINGS SHALL INCLUDE, AT MIN., THE FOLLOWING: 1. SLOOPE OR DEPTH, SPAN AND SPACING.

- 2. LOCATION OF ALL JOINTS.
- 3. REQUIRED BEARING WIDTH.
- 4. DESIGN LOADS AS APPLICABLE
 - 4.1 TOP CHORD LIVE LOAD
 - 4.2 TOP CHORD DEAD LOAD 4.3 BOTTOM CHORD LIVE LOAD
 - 4.4 BOTTOM CHORD DEAD LOAD
 - 4.5 CONCENTRATED LOADS & POINTS OF

THEIR

APPLICATION 4.6 CONTROLLING WIND &

EARTHQUAKE LOADS.

5. ADJUSTMENT TO LUMBER & JOINT CONNECTOR DESIGN VALUES FOR CONDITION OF USE.

6. EACH REACTION FORCE AND DIRECTION.

7. JOINT CONNECTOR TYPE & DESCRIPTION SUCH AS SIZE, THICKNESS OR GAGE & THE DIMENSIONAL LOCATION OF EACH JOINT CONNECTOR EXCEPT WHERE

SYMMETRICALLY LOCATED RELATIVE TO THE JOINT INTERFACE. 8. LUMBER SIZE, SPECIES & GRADE FOR

EACH MEMBER. 9. CONNECTION REQUIREMENTS FOR: 9.1 TRUSS TO GIRDER-TRUSS

9.2 TRUSS PLY TO PLY

9.3 FIELD SPLICES

BRACED IN ACCORDANCE WITH ACCEPTED INDUSTRY PRACTICE SUCH AS THE SBCA BUILDING COMPONENT SAFETY INFORMATION (BCSI) GUIDE TO GOOD PRACTICE FOR HANDLING, **INSTALLING & BRACING OF METAL** PLATE CONNECTED WOOD TRUSSES.

TRUSS MEMBERS SHALLNOT BE CUT, NOTCHED, DRILLED, SPLICED OR OTHERWISE ALTERED IN ANY WAY WITHOUT THE APPROVAL OF A REGISTERED DESIGN PROFESSIONAL.

10. CALCULATED DEFLECTION RATIO

11. MAXIMUM AXIAL COMPRESSION

COMPATIBLE TO THE DESIGNED SIZE,

PERMANENT CONTINUOUS LATERAL

BRACING. FORCES SHALL BE SHOWN

ON THE TRUSS DESIGN DRAWING OR

ON SUPPLEMENTAL DOCUMENTS.

MEMBER BRACING LOCATION.

12. REQUIRED PERMANENT TRUSS

THE DESIGN & MANUFACTURE OF

METAL-PLATE-CONNECTED WOOD

DRAWINGS SHALL BE PREPARED BY A

REGISTERED PROFESSIONAL WHERE

TRUSSES SHALL COMPLY WITH

ANSI/TPI 1. THE TRUSS DESIGN

REQUIRED BY THE STATUTES OF

TRUSSES SHALL BE BRACED TO

PREVENT ROTATION & PROVIDE

FOR THE BUILDING & ON THE

LATERAL STABILITY IN ACCORDANCE

WITH THE REQUIREMENTS SPECIFIED

INDIVIDUAL TRUSS DESIGN DRAWINGS.

REQUIREMENTS, TRUSSES SHALL BE

IN THE ABSENCE OF SPECIFIC BRACING

IN THE CONSTRUCTION DOCUMENTS

PRINCE GEORGE'S COUNTY.

CONNECTIONS & ANCHORAGE OF THE

FORCES IN THE TRUSS MEMBERS

& TOTAL LOAD.


AND MAXIMUM DESCRIPTION FOR LIVE


ISSUE DATES

SHEET <u>15</u> OF <u>32</u>

	WINDOW SCHEDULE											
WINDOW TAG	WIDTH	HEIGHT	TYPE	ELEVATION	MATERIAL	GLAZING	MANUFACTURER					
Α	3'-0"	5′-0″	DOUBLE HUNG	А	WOOD	матсн ех.	TBD					
В	2′-8″	1'-0"	TRANS□M	В	WOOD	MATCH EX.	TBD					
С	2′-7″	1'-6"	DOUBLE HUNG	С	WOOD	матсн ех.	TBD					

1. ALL NEW WINDOWS <u>U-VALUE</u> TO BE MINIMUM <u>0.30</u> AND GLAZING <u>SHGC</u> TO BE <u>0.27</u>. 2. ALL NEW WINDOWS SHALL MATCH EXISTING WINDOW IN PROFILE, GRID PATTERN, AND STYLE

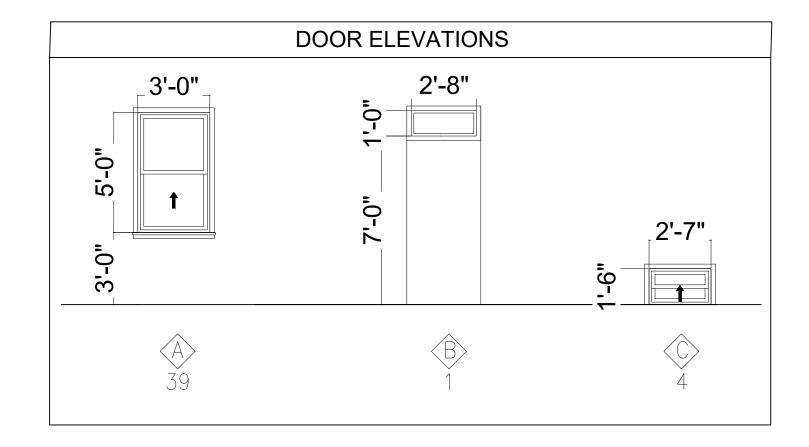

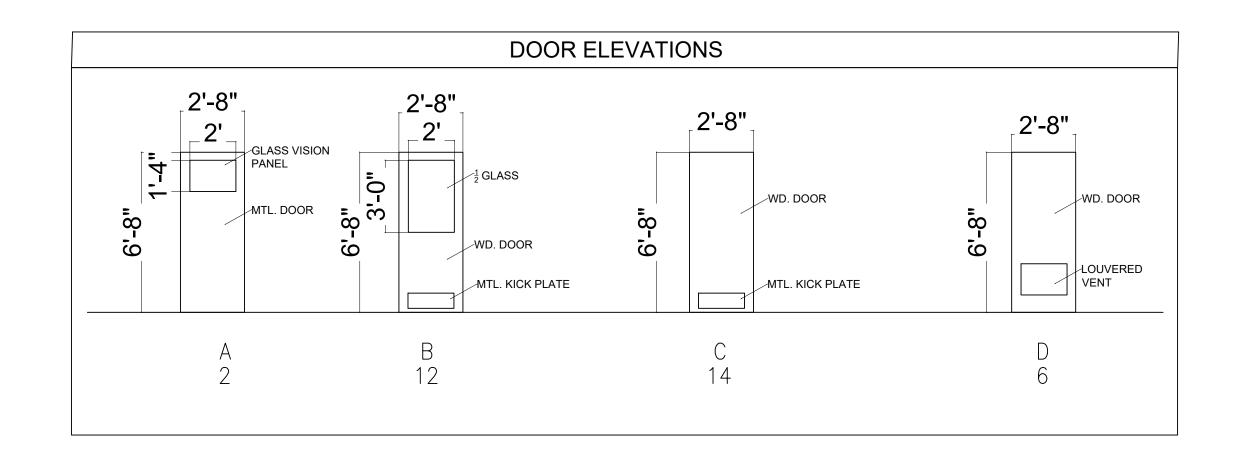

	DOOR SCHEDULE													
DOOR TAG	USE		DOOR SIZ	ZE		DOOR TY	/PE		FRAME TYP	PΕ			HARDWARE	
		WIDTH	HEIGHT	THICKNESS	ELEV.	MATERIAL	. FINISH	ELEV.	MATERIAL	FINISH	FIRE RATED	FINISH	LATCH/ LOCKS	HDW
001	STAIRS	2′-8″	6′-8″	0'-1 3/8"	С	MTL.	PTD./ST.	F1	ALUM.	ALUM.	N	ALUM.	PASSAGE	SET 3
002	STORAGE	2′-8″	6'-8"	0'-1 3/8"	D	MTL.	PTD./ST.	F1	ALUM.	ALUM.	N	ALUM.	CLASSRM.	SET 4
003	M/E ROOM	2′-8″	6′-8″	0'-1 3/8"	D	MTL.	PTD./ST.	F2	ALUM.	ALUM.	N	ALUM.	CLASSRM.	SET 4
004	RESTROOM	2′-8″	6'-8"	0'-1 3/8"	С	MTL.	PTD./ST.	F2	ALUM.	ALUM.	N	ALUM.	PRIVACY	SET 1
101	ENTRY	2′-8″	6'-8"	0'-1 3/4"	Α	GL.	ALUM.	F2	ALUM.	ALUM.	N	ALUM.	ENTRY	SET 2
102	CLASSRM,	2′-8″	6'-8"	0'-1 3/8"	В	W.D.	PTD./ST.	F2	ALUM.	ALUM.	N	ALUM.	PRIVACY	SET 1
103	STAIRS	2′-8″	6′-8″	0'-1 3/8"	С	W.D.	PTD./ST.	F2	ALUM.	ALUM.	N	ALUM.	PASSAGE	SET 3
104	CONF. RM.	2′-8″	6'-8"	0'-1 3/8"	В	W.D.	PTD./ST.	F1	ALUM.	ALUM.	N	ALUM.	CLASSRM.	SET 4
105	RESTROOM	2′-8″	6′-8″	0'-1 3/4"	С	GL.	ALUM.	F1	ALUM.	ALUM.	N	ALUM.	PRIVACY	SET 1
106	RESTROOM	2′-8″	6′-8″	0'-1 3/4"	С	GL.	ALUM.	F2	ALUM.	ALUM.	N	ALUM.	PRIVACY	SET 1
107	RESTROOM	2′-8″	6'-8"	0'-1 3/8"	С	W.D.	PTD./ST.	F2	ALUM.	ALUM.	N	ALUM.	PRIVACY	SET 1
108	THERAPEUTIC RM.	2′-8″	6′-8″	0'-1 3/8"	В	W.D.	PTD./ST.	F2	ALUM.	ALUM.	N	ALUM.	CLASSRM.	SET 4
109	RESTROOM	2′-8″	6′-8″	0'-1 3/8"	С	W.D.	PTD./ST.	F2	ALUM.	ALUM.	N	ALUM.	PRIVACY	SET 1
110	CLASSRM,	2′-8″	6′-8″	0'-1 3/8"	В	W.D.	PTD./ST.	F2	ALUM.	ALUM.	N	ALUM.	CLASSRM.	SET 4
111	ENTRY	2′-8″	6′-8″	0'-1 3/4"	А	W.D.	PTD./ST.	F2	ALUM.	ALUM.	N	ALUM.	ENTRY	SET 2
201	STAIRS	2′-8″	6'-8"	0'-1 3/8"	С	W.D.	PTD./ST.	F1	ALUM.	ALUM.	N	ALUM.	PASSAGE	SET 3
202	CLOSET	2'-8"	6'-8"	0'-1 3/8"	D	W.D.	PTD./ST.	F1	ALUM.	ALUM.	N	ALUM.	PASSAGE	SET 3
203	RESTROOM	2'-8"	6'-8"	0'-1 3/8"	С	W.D.	PTD./ST.	F2	ALUM.	ALUM.	N	ALUM.	PRIVACY	SET 1
204	CLASSRM.	2'-8"	6'-8"	0'-1 3/8"	В	W.D.	PTD./ST.	F2	ALUM.	ALUM.	N	ALUM.	CLASSRM.	SET 4
205	RESTROOM	2′-8″	6'-8"	0'-1 3/8"	С	W.D.	PTD./ST.	F2	ALUM.	ALUM.	N	ALUM.	PRIVACY	SET 1
206	CLASSRM.	2′-8″	6′-8″	0'-1 3/8"	В	W.D.	PTD./ST.	F2	ALUM.	ALUM.	N	ALUM.	CLASSRM.	SET 4
207	CLASSRM,	2′-8″	6'-8"	0'-1 3/8"	В	W.D.	PTD./ST.	F2	ALUM.	ALUM.	N	ALUM.	CLASSRM.	SET 4
208	RESTROOM	2′-8″	6'-8"	0'-1 3/8"	С	W.D.	PTD./ST.	F2	ALUM.	ALUM.	N	ALUM.	PRIVACY	SET 1
209	RESTROOM	2'-8"	6'-8"	0'-1 3/8"	С	W.D.	PTD./ST.	F2	ALUM.	ALUM.	N	ALUM.	PRIVACY	SET 1
210	THERAPEUTIC RM.	2′-8″	6'-8"	0'-1 3/8"	В	W.D.	PTD./ST.	F3	ALUM.	ALUM.	N	ALUM.	CLASSRM.	SET 4
301	STAIRS	2′-8″	6'-8"	0'-1 3/8"	С	GL.	PTD./ST.	F1	ALUM.	ALUM.	N	ALUM.	ENTRY	SET 2
302	CLOSET	2′-8″	6'-8"	0'-1 3/8"	D	W.D.	PTD./ST.	F2	ALUM.	ALUM.	N	ALUM.	PASSAGE	SET 3
303	KITCHENETTE	2′-8″	6'-8"	0'-1 3/8"	В	W.D.	PTD./ST.	F2	ALUM.	ALUM.	N	ALUM.	PASSAGE	SET 3
304	CLOSET	2′-8″	6'-8"	0'-1 3/8"	D	W.D.	PTD./ST.	F2	ALUM.	ALUM.	N	ALUM.	PASSAGE	SET 3
305	DFFICE	2′-8″	6'-8"	0'-1 3/8"	В	W.D.	PTD./ST.	F2	ALUM.	ALUM.	N	ALUM.	ENTRY	SET 2
306	OFFICE	2′-8″	6'-8"	0'-1 3/8"	В	W.D.	PTD./ST.	F2	ALUM.	ALUM.	N	ALUM.	PASSAGE	SET 3
307	CLOSET	2'-8"	6'-8"	0'-1 3/8"	D	W.D.	PTD./ST.	F2	ALUM.	ALUM.	N	ALUM.	PASSAGE	SET 3
308	OFFICE	2′-8″	6'-8"	0'-1 3/8"	В	W.D.	PTD./ST.	F2	ALUM.	ALUM.	N	ALUM.	ENTRY	SET 2

W.D. PTD./ST. F3

IMPORTANT NOTE:

1. ALL DIMENSIONS ARE ONLY FOR INFORMATION;

RESTROOM

- 2. PROVIDE & INSTALL SECURITY GRILLES FOR ENTRY DOORS.
- 3. EXTERIOR DOORS <u>U-VALUE</u> TO BE MINIMUM <u>0.30</u> AND TRANSOM GLAZING <u>SHGC</u> TO BE <u>0.27</u>.
- 4. EXISTING TO REMAIN MECHANICAL ROOM AND RESTROOM DOORS ORBITAL KNOBS ARE TO BE REPLACED WITH LEVER SETS.
- 5. STAIRWELL DOORS SHALL HAVE CRASH BARS INSTALLED ON THE STAIRWELL SIDE OF THE DOOR.

6'-8" 0'-1 3/8"

6. * EQUALS SECURITY DOOR.

PROJECT NO: CHECKED BY: DGG

| PASSAGE | SET 3

ALUM.

ISSUE DATES 2.27 ORIG. SUB.

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1010 EAST 43RD STREET BALTIMORE, MD. 21212 COMMERCIAL RENOVATION

A6.01


SCHEDULES

SHEET <u>16</u> **OF** <u>32</u>

CONSTRUCTION DOCUMENTS

IMPORTANT NOTE:

DUUB CCHEDIII E

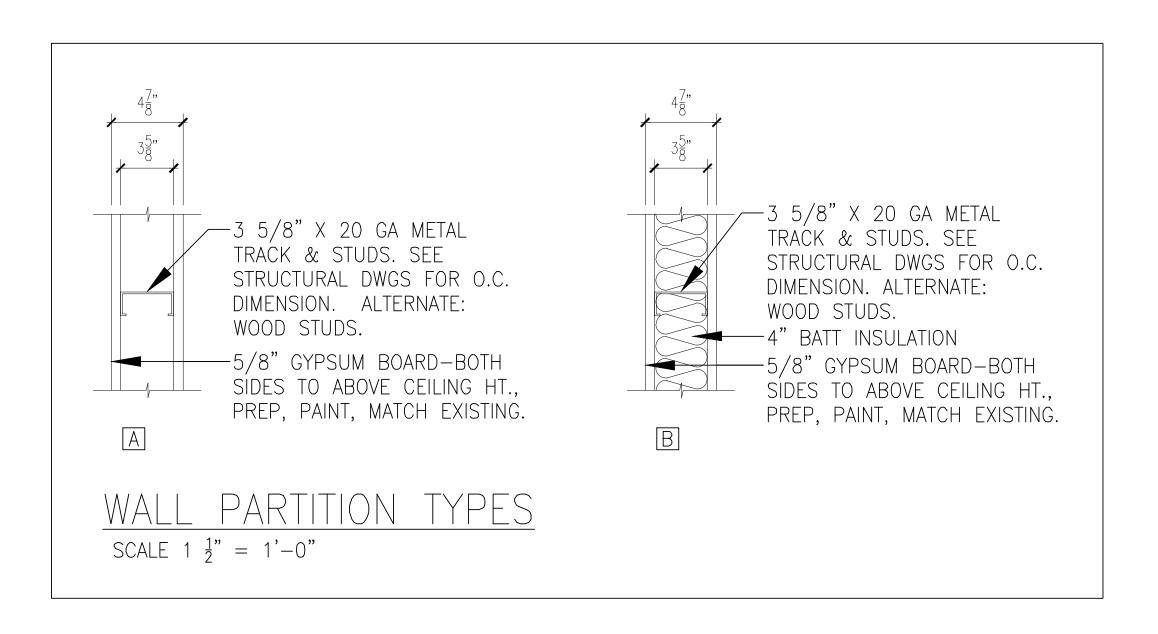

FINISH SCHEDULE											
		FLC	OOR	BA	SE	WAL	LS	CE	LING		
FLOOR	ROOM NAME	MAT'L	FIN.	MAT'L	PAINT	MAT'L	PAINT	MAT'L	PAINT		
	INDOOR PLAY AREA	CONC.	LVT	VINYL	N/A	GWB	PAINT	GWB	N/A		
	STORAGE	CONC.	LVT	VINYL	N/A	GWB	PAINT	GWB	N/A		
BASEMENT FLOOR	RESTROOM	CONC.	LVT	VINYL	N/A	GWB	PAINT	GWB	N/A		
	STAIRS	CONC.	LVT	VINYL	N/A	GWB	PAINT	GWB	N/A		
	M/E ROOM	CONC.	LVT	VINYL	N/A	GWB	PAINT	GWB	N/A		
	LOBBY	³ / ₄ " OSB	LVT	VINYL	N/A	GWB	PAINT	GWB	N/A		
	HALL	3/4" OSB	LVT	VINYL	N/A	GWB	PAINT	GWB	N/A		
FIRST FLOOR	CLASSROOM	3" OSB	LVT	VINYL	N/A	GWB	PAINT	GWB	N/A		
	RESTROOM	₹ OSB	LVT	VINYL	N/A	GWB	PAINT	GWB	N/A		
	THERAPEUTIC ROOM	3/" OSB	LVT	VINYL	N/A	GWB	PAINT	GWB	N/A		
	CONF. ROOM	3 <u>"</u> OSB	LVT	VINYL	N/A	GWB	PAINT	GWB	N/A		
	HEADSTART CLASSROOM	3ª OSB	LVT	VINYL	N/A	GWB	PAINT	GWB	N/A		
	HALL	³ ⁄ ₄ " OSB	LVT	VINYL	N/A	GWB	PAINT	GWB	N/A		
SECOND FLOOR	CLOSET	¾" OSB	LVT	VINYL	N/A	GWB	PAINT	GWB	N/A		
	RESTROOM	3/" OSB	LVT	VINYL	N/A	GWB	PAINT	GWB	N/A		
	THERAPEUTIC ROOM	3" OSB	LVT	VINYL	N/A	GWB	PAINT	GWB	N/A		
	KITCHENETTE	3/4" OSB	LVT	VINYL	N/A	GWB	PAINT	GWB	N/A		
	HALL	3ª OSB	LVT	VINYL	N/A	GWB	PAINT	GWB	N/A		
THIRD FLOOR	CLOSET	³ 4" OSB	LVT	VINYL	N/A	GWB	PAINT	GWB	N/A		
	RESTROOM	³ ₄" OSB	LVT	VINYL	N/A	GWB	PAINT	GWB	N/A		
	OFFICE	³ ₁" OSB	LVT	VINYL	N/A	GWB	PAINT	GWB	N/A		

∩TF·

- 1. CONTRACTOR SELECTIONS SHALL BE VERIFIED VIA SUBMITTAL PROCESS
- 2. PAINT COLORS TO BE DETERMINED AND SELECTED BY OWNER

SULTON CAMPBELL BRITT & ASSOCIATES, P.C.
Architecture * Historic Preservation * Planning * LEED" Consulting
Founded 1964

1010 EAST 43RD STREET
BALTIMORE, MD. 21212
COMMERCIAL RENOVATION

ISSUE DATES

ISSUE DATES
2.27 ORIG. SUB.

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PROJECT NO:

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CHECKED BY: DGG

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CONTENT

FINISH


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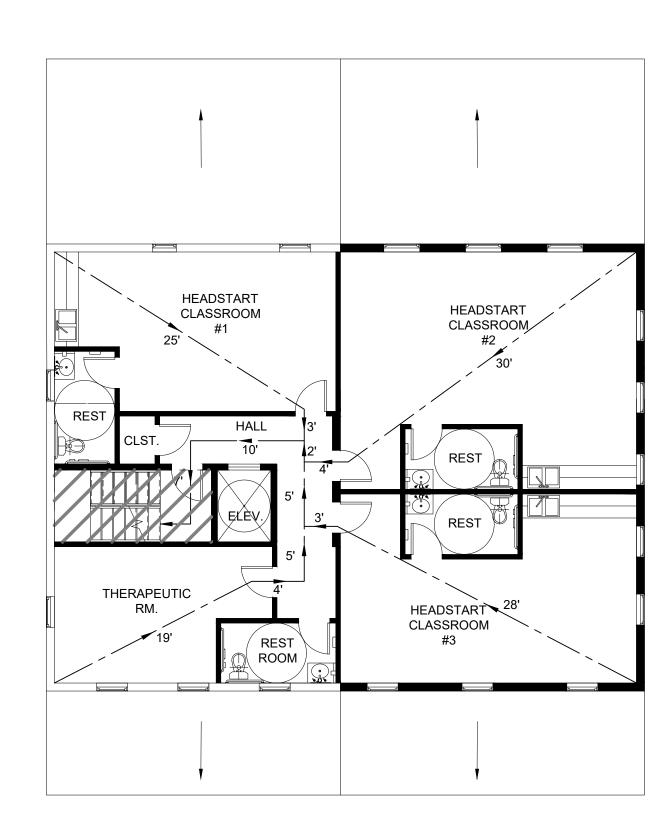
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SHEET <u>17</u> OF <u>32</u>


1 HR. VERTICAL SEPARATION







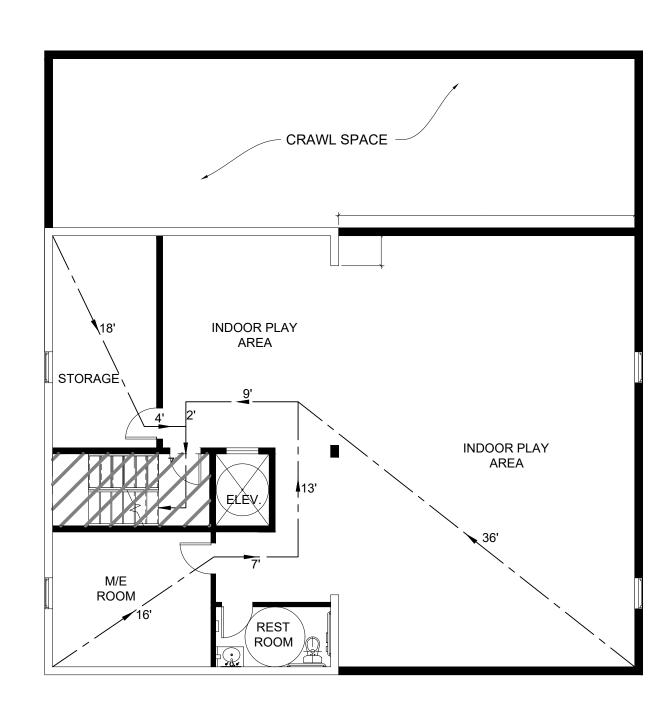

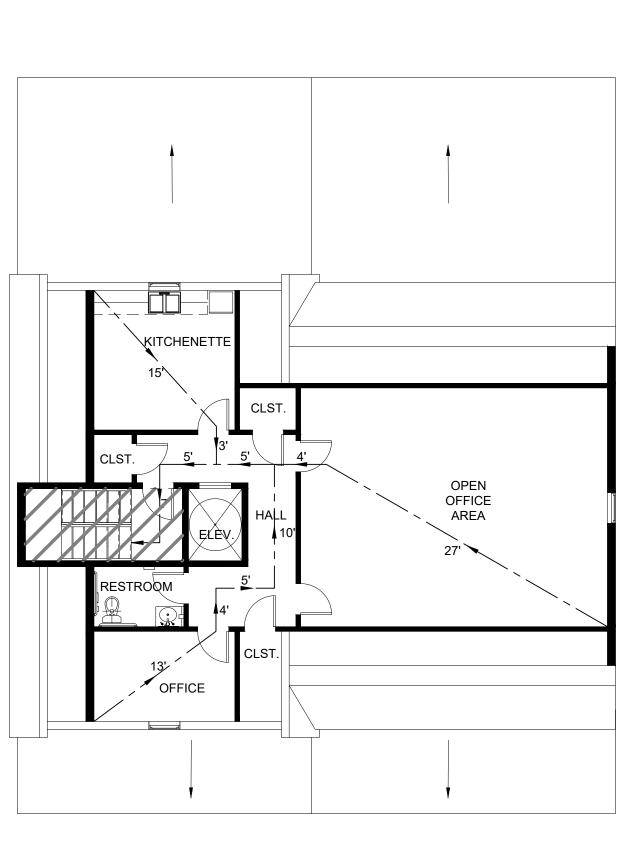

4 THIRD FLOOR EGRESS PLAN
A7.01 SCALE: 1/8" = 1'-0"

1 2.27 ORIG. SUB.

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PLANS

A7.01

SHEET <u>18</u> OF <u>32</u>

MECHANICAL

SPECIFICATIONS

1. SCOPE

THE WORK COVERED IN THIS SECTION OF THE SPECIFICATIONS CONSISTS OF FURNISHING ALL LABOR, EQUIPMENT, AND MATERIAL AND IN PERFORMING ALL OPERATIONS IN CONNECTION WITH THE INSTALLATION OF THE COMPLETE AIR CONDITIONING AND HEATING SYSTEM. ALL WORK WILL BE COMPLETE AND IN ACCORDANCE WITH THIS SECTION OF THE SPECIFICATIONS AND APPLICABLE DRAWINGS, AND WILL BE SUBJECT TO THE TERMS AND CONDITIONS OF THE CONTRACT.

2. SPECIFICATIONS AND DRAWINGS

THE MECHANICAL DRAWINGS INDICATE THE GENERAL ARRANGEMENT OF THE AIR CONDITIONING AND HEATING SYSTEM. THESE SPECIFICATIONS AND DRAWINGS SHALL SUPPLEMENT EACH OTHER. EQUIPMENT, DUCTWORK AND PIPING SHALL FIT INTO THE SPACE ALLOCATED AND SHALL PROVIDE ALL NECESSARY CLEARANCE FOR SERVICING AND MAINTENANCE.

3. CODES AND STANDARDS

THE WORK SHALL COMPLY WITH THE LATEST APPLICABLE REQUIREMENTS FOR THE NFPA AND ALL LOCAL CODES GOVERNING THIS INSTALLATION AS A MINIMUM STANDARD UNLESS SPECIFICATIONS LISTED HEREIN OR SHOWN ON THE PLANS REQUIRE A HIGHER MINIMUM STANDARD.

4. PERMITS AND FEES

THE HVAC CONTRACTOR SHALL PROCURE ALL PERMITS AND PAY ALL FEES ASSOCIATED WITH THE PERMITTING AND INSPECTION PROCESS. THE HVAC CONTRACTOR SHALL ALSO ARRANGE FOR ALL INSPECTIONS.

5. ELECTRICAL

THE ELECTRICAL CONTRACTOR SHALL FURNISH AND INSTALL ALL CONDUIT, WIRE, SEAL-TIGHT, AND DISCONNECTIONS. UNLESS OTHERWISE STIPULATED, THE ELECTRICAL CONTRACTOR SHALL CONNECT THE AIR CONDITIONING UNITS. THE HVAC CONTRACTOR WILL FURNISH ALL MATERIALS, WIRE AND CONNECT THE THERMOSTAT.

VIBRATION AND INSULATION

BOTH THE AIR HANDLER UNIT AND CONDENSING UNIT SHALL BE PLACED ON VIBRATION ISOLATORS. THE HVAC CONTRACTOR SHALL TAKE ALL NECESSARY STEPS TO ELIMINATE ALL EXCESSIVE VIBRATION AND OBJECTIONAL NOISE PROJECTED BY ANY EQUIPMENT INSTALLED UNDER THIS CONTRACT.

7. INSTALLATION

- A. THE HVAC CONTRACTOR SHALL SUPPLY ONE THERMOSTAT PER AIR SYSTEM. STAGING OF HEATING AND COOLING SHALL BE INDICATED ON THE DRAWINGS.
- ALL REFRIGERATION PIPING TO BE TYPE "L" COPPER WITH WROUGHT COPPER FITTINGS. JOINTS SHALL BE MADE WITH SILVER SOLDER.
- C. THE REFRIGERATION SUCTION LINES SHALL BE INSULATED AS FOLLOWS: ABOVE GROUND WITH 1/2 "ARMSTRONG ARMAFLEX" BELOW GROUND/SLAB WITH SAME ENCASED P.V.C. CONDUIT. INSULATION SHALL BE SLIPPED ON PIPING PRIOR TO CONNECTION. ALL BUTT JOINTS TO BE SEALED WITH AN APPROVED ADHESIVE. INSTALLATION OF CONDENSATE LINE IS BY THE HVAC CONTRACTOR. INSULATE ALL LINES RUNNING ABOVE CEILING. SEE DETAIL FOR UNDERGROUND PIPING.
- ALL DUCTWORK SHALL CONFORM TO THE RECOMMENDED CONSTRUCTION FOR LOW AND MEDIUM PRESSURE DUCTWORK AS APPROVED BY THE SHEET METAL AND AIR CONDITIONING CONTRACTORS NATIONAL ASSOCIATION. SEAL CLASS "C" FOR ALL LOW PRESSURE DUCTWORK; SEAL CLASS "A" FOR HIGH PRESSURE DUCTWORK. ALL DUCTS SHALL BE MADE OF THE BEST GRADE GALVANIZED SHEET STEEL. THE GAUGE OF THE SHEET STEEL AND DUCT SUPPORTS SHALL CONFORM TO SMACNA STANDARDS. EXPOSED ROUND DUCT SHALL BE SPIRAL LOCKSEAM OR LONGITUDINAL WELDED SEAM AS MANUFACTURED BY UNITED MCGILL SHEET METAL COMPANY. MODELS UNISEAL, UNICOAT, OR LONGITUDINAL SEAM.
- SUPPLY AND RETURN AIR REGISTERS SHALL BE TITUS OR THEIR METAL AIRE EQUIVALENT AS INDICATED ON THE DRAWINGS. ALL SUPPLY REGISTERS ARE TO BE EQUIPPED WITH MANUAL DAMPERS.
- F. EXTRACTORS AND TURNING VANES SHALL BE INSTALLED WHERE INDICATED ON THE DRAWINGS IN ADDITION TO ALL BENDS OVER 45 DEGREES.
- G. FILTERS TO BE 2" FIBERBOND DUSTLOK WITH SPOREX ANTIMICROBIAL AGENT AND DUAL PLY CONSTRUCTION, OR IT'S EQUIVALENT. FURNISH TWO ADDITIONAL FILTERS FOR EACH SIZE OF FILTER USED.

8. TESTING AND BALANCING

- A. UPON COMPLETION OF WORK, THE HVAC CONTRACTOR SHALL USE ACCURATE METERS, INSTRUMENTS OF TYPE AND SIZE AS REQUIRED DETERMINING PROPER AIR FLOW AND DISTRIBUTIONS. CONFIRM THAT ALL FUSE SIZES ARE IN ACCORDANCE WITH THE MOTOR NAMEPLATE DATA.
- AIR QUANTITIES: CHECK EACH BLOWER AND DIFFUSER AS INDICATED ON DRAWINGS FOR CORRECT AND ADEQUATE DIFFUSION. OUTSIDE AIR QUANTITIES TO BE CHECKED AND ADJUSTED AS REQUIRED. AFTER SPACES HAVE BEEN BROUGHT UP TO DESIGN TEMPERATURES AND EQUIPMENT IS FUNCTIONING PROPERLY, RE-BALANCE, IF NECESSARY, BY MEANS OF CALIBRATED THERMOMETERS PLACED IN EACH ROOM AND IN OPEN SPACES, NOT OVER 20' APART. THERMOSTATS: NO DEVIATION IN TEMPERATURE OF MORE THAN 3 DEGREES FAHRENHEIT THROUGHOUT CONDITIONED SPACE. CONTRACTOR SHALL SUBMIT COMPLETE DATA REPORT REGARDING BALANCING, IN ADDITION TO VARIOUS CONTROL SETTINGS FOR APPROVAL OF ARCHITECT.

IN	N D O O F	R M	I N I	- S F	LI	T	U	NIT
UNIT NO.	UNIT TYPE	NOMINAL COOLING CAPACITY BTUH	NOMINAL HEATING CAPACITY BTUH	AIRFLOW CFM	VOLTS/ PHASE	FLA	NET WEIGHT LBS	BASIS OF DESIGN "MITSUBISHI"
AHU-1	WALL MOUNTED	6,000	8,700	117-328	240/1	0.67	29	MSZ-FH06NA
AHU-2	WALL MOUNTED	9,000	10,900	117-328	240/1	0.67	29	MSZ-FH09NA

PROVIDE WITH WALL-MOUNTED FACTORY FURNISHED THERMOSTAT.

PROVIDE UNIT WITH CONDENSATE PUMP.

O	U T D	0 0	R N	A I	N	I -	- S	P I	J	T	UNIT	
1 IN 11 .T		NOMINAL	NOMINAL				ELECTF	RICAL	DATA	\. L		
UNIT NO.	ZONES	COOLING CAPACITY BTUH	HEATING CAPACITY BTUH	SEER	EER	HSPF	VOLTS/ PHASE	MCA	MCOP	NET WEIGHT LBS	BASIS OF DESIGN "MITSUBISHI"	
HP-1	3	22,000	25,000	20.0	13.6	10.0	208/1	22.1	25	137	MXZ-3C24NA3	
HP-2	5	43,000	53,600	19.7	9.2	9.2	208/1	32.5	40	189	MXZ-5C42NA4	

E X	H A U	S T	\mathbf{F}	A	N	S C	H	\mathbb{E}	\mathbb{D}	\mathbb{U}	L	E
UNIT		EXHAUST		FAN		ELECTR	ICAL	BAS	SIS OF			
NO.	AREA SERVED	CFM	HP (WATTS)	RPM	E.S.P. IN."	VOLTS/ PH	MCA		ESIGN ASONI(2"	REN	MARKS
EF-1	BATHROOMS	80	(15.9)	1500	0.1	240/1	0.13	FV-C)511VH	11	A,	B,C,D
REQUI B. FAN T	RKS: ACH DWELLING UNIT TO HAVE ONE (1) BATHROOM FAN THAT OPERATES CONTINUOUSLY, PROVIDING EQUIRED VENTILATION AIR TO THE SPACE. SEE PLANS FOR BATHROOM FAN LOCATIONS. AN TO BE CEILING MOUNTED ONTO BATHROOM DROP CEILING. ADIATION DAMPERS MUST BE INSTALLED IN FIRE RATED CEILING ASSEMBLIES.											

D. EXHAUST FAN HAS INTEGRAL 1.6 KW HEATER, INSTALL ON DEDICATED CIRCUIT.

SI	PLI	T	S Y	ST	E M	
LOOR	6K	9K	12K	15K	TOTAL	HP #
В	1	2	_	ı	24K	HP-2
1	2	3		ı	39K	HP-2
2	4		_		24K	HP-2
ATTIC	2	1	_	_	21K	HP-2

L	E G E N D
	SUPPLY AIR (SA)
	RETURN AIR (RA)
	EXHAUST AIR (EA)
	ROUND BRANCH DUCT W/45° TAP & MANUAL VOLUME DAMPER
	RECT. BRANCH DUCT W/45° TAP & MANUAL VOLUME DAMPER
12x6	RECTANGULAR DUCT
120	ROUND DUCT (DIAMETER)
	THERMOSTAT (WALL MOUNTED)
	FLEXIBLE DUCT (SINGLE LINE)
	VOLUME CONTROL DAMPER
	SQUARE-ROUND DUCT TRANSITION

ENERGY VERIFICATION

- (1) ANY SUPPLY DUCTS LOCATED IN ATTIC SPACES ARE INSULATED OUTSIDE BUILDING ENVELOPE ARE INSULATED >/= R-6.
- (2) ALL JOINTS AND SEAMS OF AIR DUCTS, AIR-HANDLERS, AND
- (4) HVAC PIPING CARRYING FLUIDS > 105°F OR FLUIDS < 55°F ARE

- (7) TOTAL DUCT LEAKAGE TEST MUST BE </= 8 CFM/100 sqft W/ AIR HANDLER INSTALLED.
- (8) AIR HANDLER LEAKAGE DESIGNED BY MFR AT </= 2% OF AIR FLOW.
- (9) HVAC EQUIPMENT TYPE AND CAPACITY SHALL BE AS PER PLANS.
- PROGRAMMABLE T'STATS SHALL BE PROVIDED ON FORCED AIR FURNACE WITH 5 DEGREE F DEADBAND CAPABILITY.

- (13) AIR LEAKAGE TEST SHALL BE PERFORMED TO COMPLY W/ IECC

EQUIPMENT NOMENCLATURE

- >/= R-8. ALL OTHER DUCTS IN UNCONDITIONED SPACES OR
- FILTER BOXES ARE SEALED.
- (3) BUILDING CAVITIES ARE NOT USED AS DUCTS OR PLENUMS.
- INSULATED TO >/= R-3.
- (5) INSULATION ON HVAC PIPING SHALL BE PROTECTED.

#/

- (6) AUTO/GRAVITY DAMPERS INSTALLED ON ALL INTAKES/EXHAUSTS.

- (11) HEAT PUMP T'STAT INSTALLED ON HEAT PUMPS.
- (12) HEATING AND COOLING EQUIPMENT IS SIZED BASED ON ACCA MANUAL S BASED ON LOADS CALCULATED PER ACCA MANUAL J
- 402.4.1.2. MAX AIR CHANGE PER HOUR IS < 5 AC/HR
- (14) MAXIMUM ALLOWABLE LEAKAGE RATES OF DAMPERS PROVIDED TO UNITS, 40 CFM/SQFT FOR NON-MOTORIZED DAMPERS

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NOTES:

DunlapDesign consultants

(443)742-7227

2

DRAWING NO:

NO SCALE

P

MECHANICAL

BASEMENT

CRAWL SPACE ++++ **INDOOR PLAY** STORAGE AREA INDOOR PLAY AREA M/E ROOM

REST

GENERAL NOTES

A. REFER TO DRAWING M-1 FOR SCHEDULES & SPECIFICATIONS.

B. DRAWINGS ARE DIAGRAMMATICAL BY NATURE AND SHOULD NOT BE SCALED.

C. COORDINATE WITH OWNER FOR EXACT LOCATION OF AIR DEVICES IN CEILING.

D. ALL CONTRACTORS PRIOR TO BID SUBMISSION PROCESS SHALL VISIT PROPOSED WORK SITE AND FIELD VERIFY ALL EXISTING CONDITIONS. ANY CONDITIONS THAT DIFFER FROM THAT SHOWN ON THIS PLAN SHALL BE REPORTED TO ARCHITECT/ENGINEER SO THAT NEW AND REVISED BID DRAWINGS OR INFORMATION MAY BE ISSUED. MODIFICATIONS TO SCOPE OF WORK WHICH RESULTS FROM CONTRACTORS NEGLECT TO VISIT WORK SITE PRIOR TO SUBMITTING BID, SHALL BE THE CONTRACTORS SOLE RESPONSIBILITY.

DRAWING NOTES

INSTALL, SIZE, AND ROUTE REFRIGERATION PIPING AS RECOMMENDED BY SPLIT SYSTEM MANUFACTURER. ALL EXTERIOR PIPING TO CONDENSING UNIT SHALL BE PROTECTED USING A PVC LINE SET COVER.

- 2. CONDENSATE PIPING TO TERMINATE ON GRADE. PIPE SIZE AND ROUTING TO BE DETERMINED IN-FIELD.
- . EXHAUST DUCTWORK TO RUN WITHIN DROP CEILING.
- 4. DUCTWORK TO RUN WITHIN BULKHEAD BELOW RATED CFILING
- 5. 4¢ BATHROOM EXHAUST DUCT TO TERMINATE ON ROOF WITH ROOF CAP.
- . BATHROOM EXHAUST FAN TO RUN CONTINUOUSLY TO PROVIDE REQUIRED VENTILATION.
- COORDINATE DUCT ROUTING UP THRU THIRD FLOOR UP THRU ROOF.



NOTES:

SCALE:

DAMAING NO.

M₋₂

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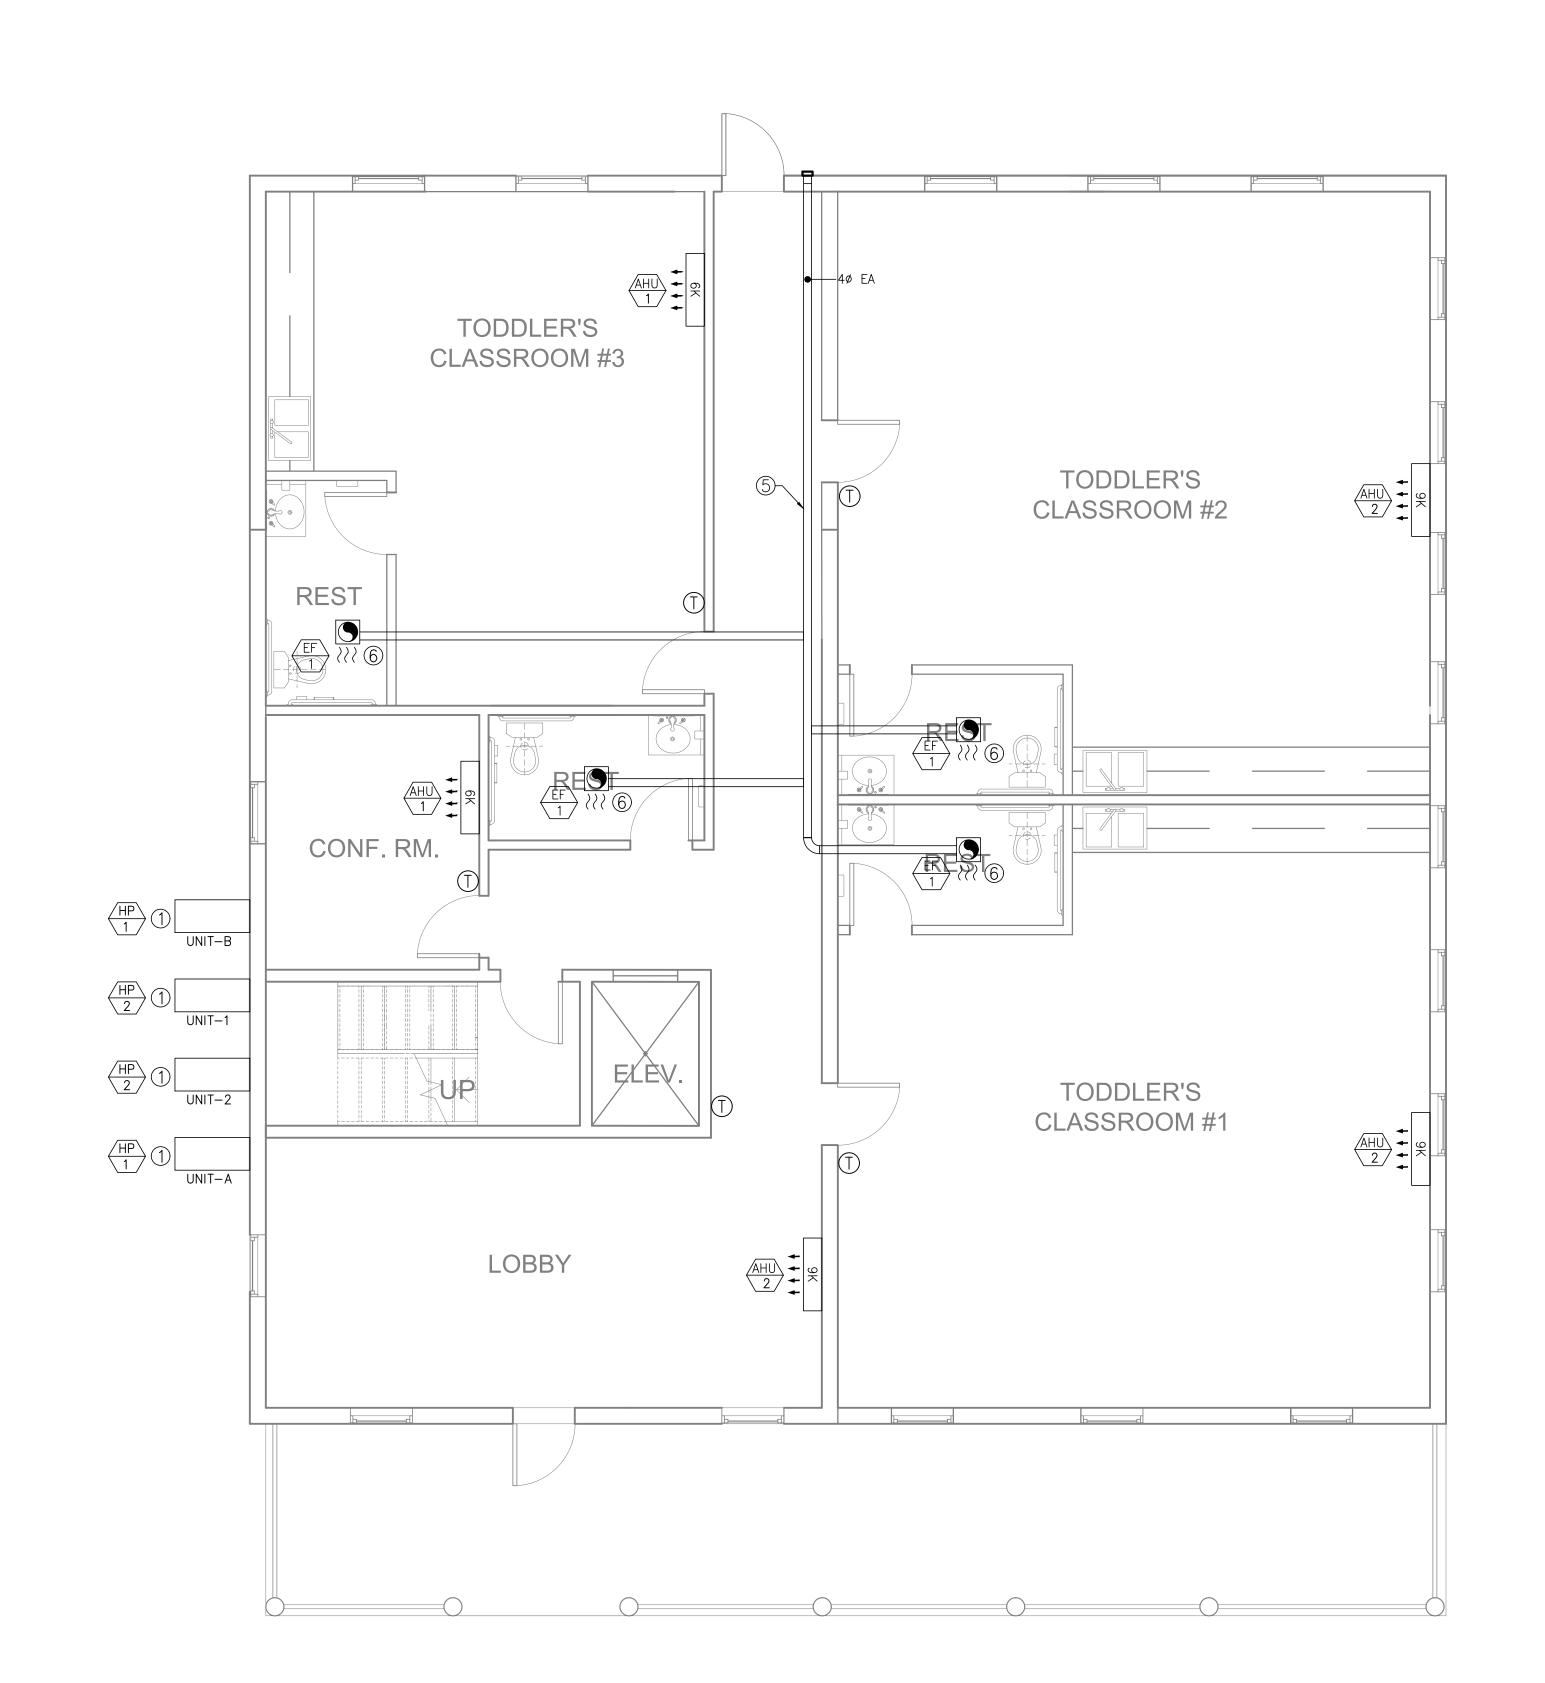
NOTES:

1010 EAST

MECHANIC

1ST FLOOR

STREET 43RD



SPECIFICATIONS.

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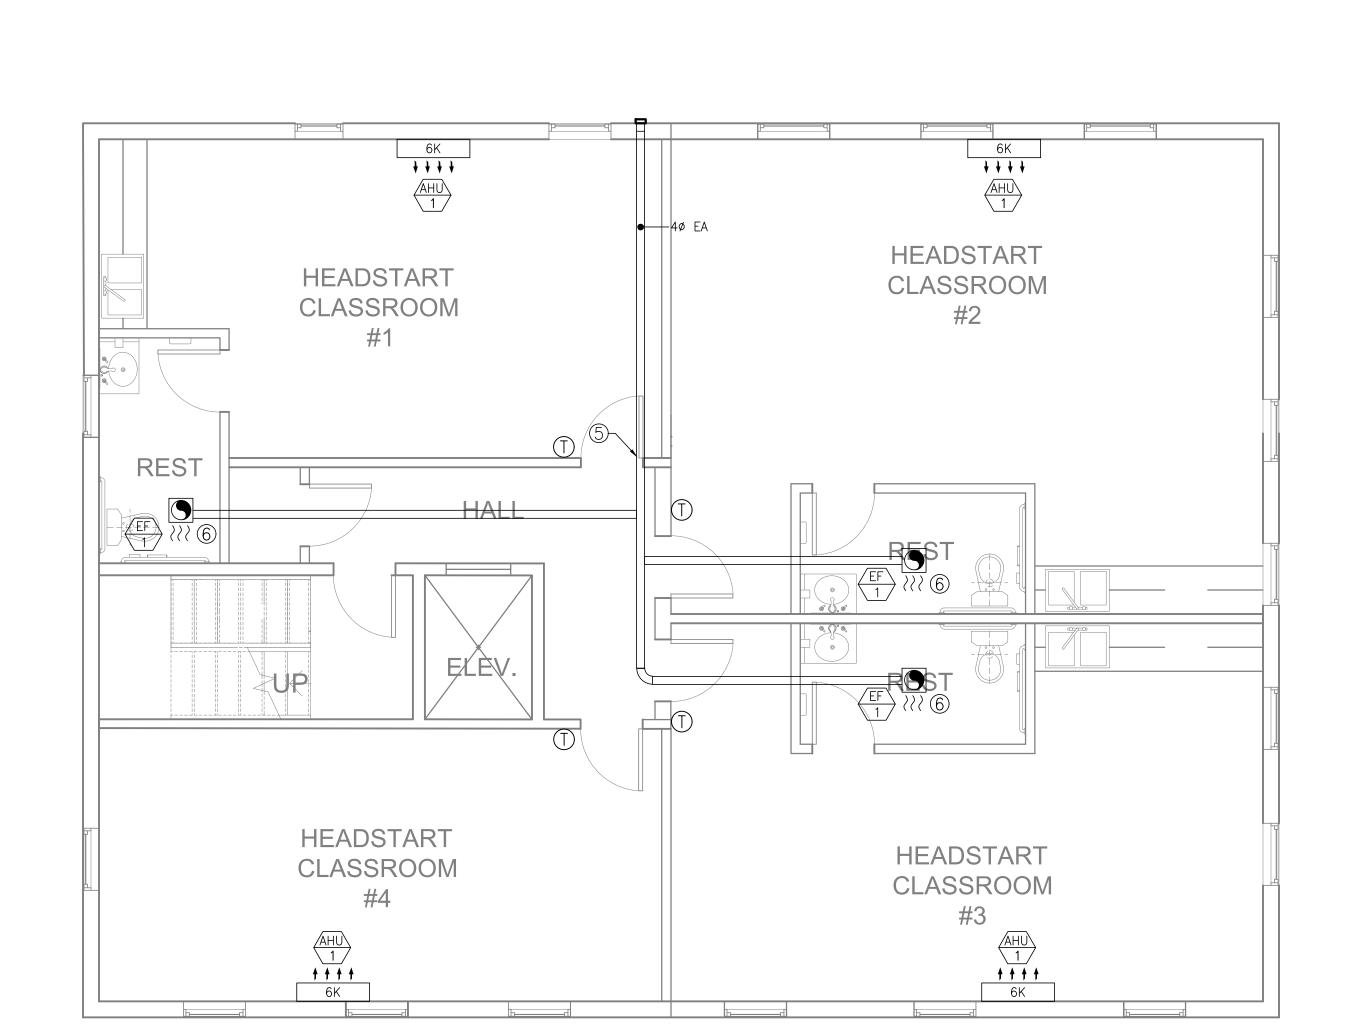
NOTES:

2 2 MD

BALTIMOR STREET 2ND FLOOR 43RD 1010 EAST

7

MECHANICAL



A. REFER TO DRAWING M-1 FOR SCHEDULES & SPECIFICATIONS.

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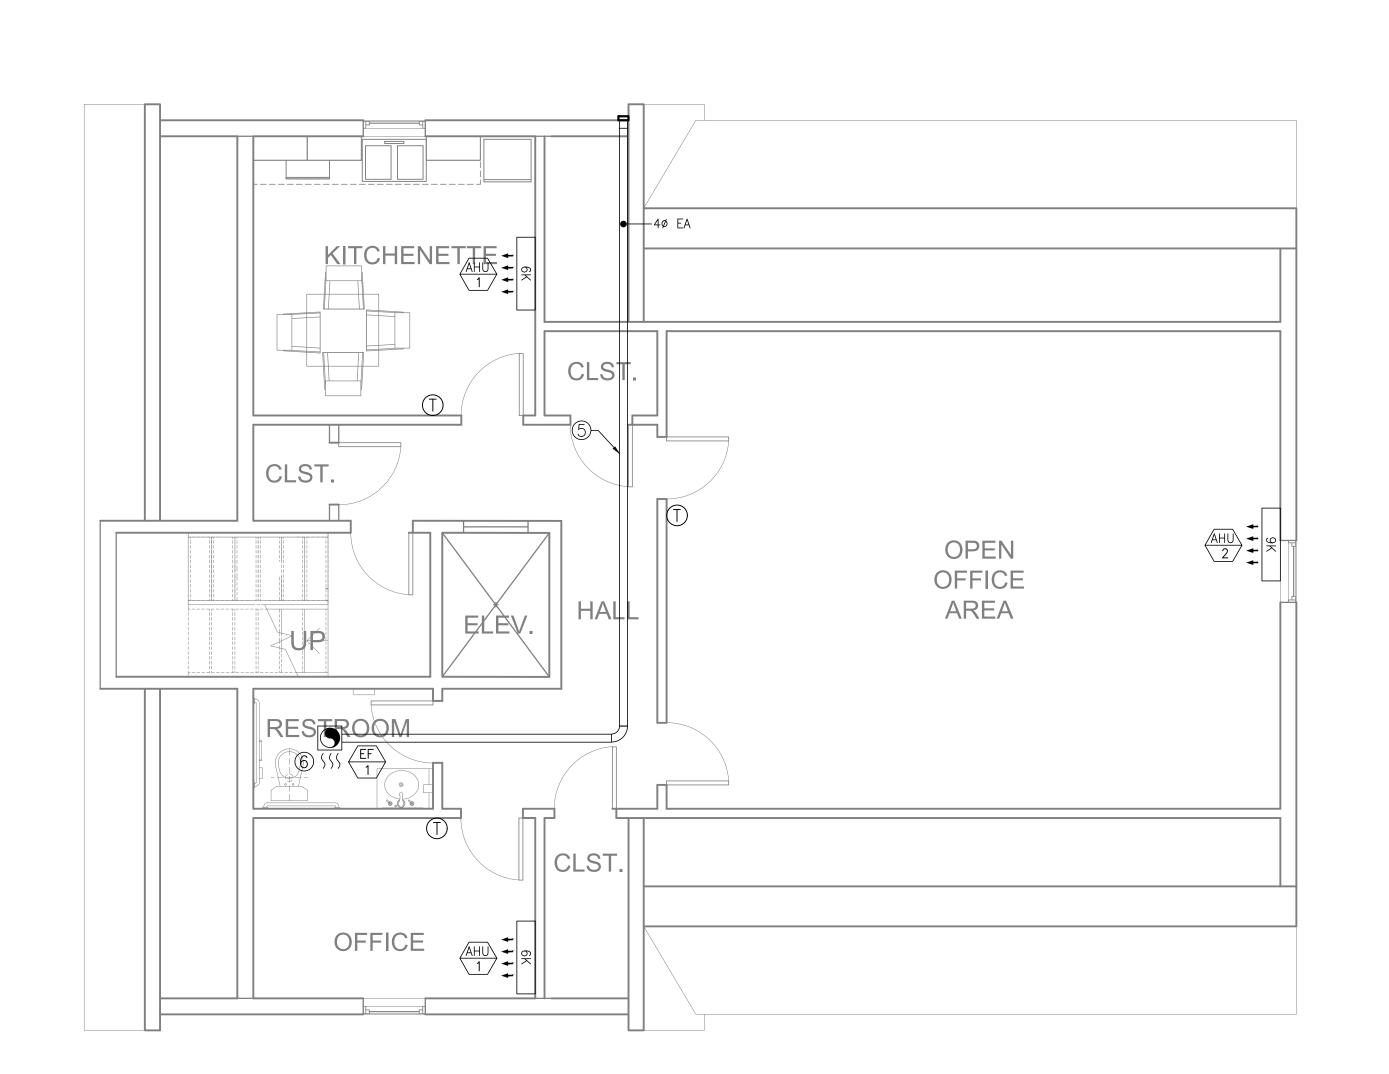
Dunlap Design consultants (443)742-7227

NOTES:

S BALTIMOR CARE CHILD 1010 EAST

- MECHANICAL

STREET, **43RD**



ELECTRICAL SPECIFICATIONS:

- A. GENERAL: THE REQUIREMENTS OF THE GENERAL, SUPPLEMENTARY AND SPECIAL CONDITIONS OF THE CONTRACT SPECIFICATIONS AND DRAWINGS ARE HEREBY MADE A PART OF THIS SECTION OF THE SPECIFICATIONS. IT IS THE INTENT OF THE PLANS AND SPECIFICATIONS TO PROVIDE A COMPLETE AND OPERATING INSTALLATION INCLUDING ALL OBVIOUSLY NECESSARY ITEMS EVEN
- OPERATING INSTALLATION INCLUDING ALL OBVIOUSLY NECESSARY ITEMS EVEN THOUGH ITEMS ARE NOT INDICATED ON THE DRAWINGS OR SPECIFICATIONS.

 B. PERMITS, SALES TAX, ETC.: THE CONTRACTOR SHALL SECURE AND PAY FOR ALL PERMITS, STATE SALES TAX, FEDERAL EXCISE TAX, ROYALTIES AND OTHER TAXES OR FEES AS REQUIRED FOR INSTALLATION OF A COMPLETE

SYSTEM AS OUTLINED HEREIN AND AS SHOWN ON THE PLANS. THE CONTRACTOR SHALL SECURE ALL NECESSARY LICENSES AND INSURANCE.

- C. CODES: THE WORK SHALL COMPLY WITH LATEST APPLICABLE REQUIREMENTS
 OF THE NFPA AND ALL LOCAL CODES GOVERNING THIS INSTALLATION AS A
 MINIMUM STANDARD UNLESS SPECIFICATIONS LISTED HEREIN OR SHOWN ON
 THE PLANS REQUIRE A HIGHER MINIMUM STANDARD.
- BRANDS OF EQUIPMENT: WHERE ONE MANUFACTURER ONLY IS NAMED, THE BIDS SHALL BE BASED ON FURNISHING EQUIPMENT OR MATERIALS BY THIS MANUFACTURER. PRODUCTS OF OTHER MANUFACTURERS WILL BE CONSIDERED FOR USE IF THE ITEM REQUESTED FOR SUBSTITUTION IS EQUAL TO THAT SPECIFIED. WHERE NO MANUFACTURERS ARE NAMED, THE CONTRACTOR SHALL SELECT EQUIPMENT OR MATERIAL WHICH MEETS THE
- E. DEPARTURES FROM DRAWINGS: THE CONTRACT DRAWINGS INDICATE THE EXTENT AND GENERAL ARRANGEMENTS OF EQUIPMENT AND SYSTEMS. IF ANY DEPARTURES FROM THE CONTRACT DRAWINGS ARE DEEMED NECESSARY BY THE CONTRACTOR, DETAILS OF SUCH DEPARTURES AND REASONS THEREFORE SHALL BE SUBMITTED FOR APPROVAL. NO SUCH DEPARTURES SHALL BE MADE WITHOUT PRIOR WRITTEN APPROVAL.
- F. CHANGES: THE CONTRACTOR SHALL CONFORM TO ALL REASONABLE CHANGES WITHOUT ADDITIONAL COST.
- G. ERRORS AND OMISSIONS: ALL OBVIOUS ERRORS AND/OR OMISSIONS IN THE ABOVE MENTIONED DOCUMENTS SHALL BE CALLED TO THE ATTENTION OF THE GC AT LEAST FOUR DAYS PRIOR TO THE BID DATE. IF NOTIFICATION IS NOT RECEIVED, NO EXTRAS TO THE ORIGINAL DRAWINGS AND SPECIFICATIONS WILL BE AUTHORIZED.
- H. GUARANTEE: THE CONTRACTOR SHALL PROVIDE A GUARANTEE AGAINST DEFECTIVE WORKMANSHIP, MATERIALS OR EQUIPMENT FOR A PERIOD OF ONE YEAR FROM THE DATE OF ACCEPTANCE. THIS GUARANTEE SHALL INCLUDE ALL COSTS ENCOUNTERED IN THE REPLACING OF DEFECTIVE WORK OR MATERIALS. THE CONTRACTOR SHALL CONVEY TO THE OWNER ANY ADDITIONAL GUARANTIES OR WARRANTIES PROVIDED BY THE MANUFACTURER OF AN INDIVIDUAL ITEM, EQUIPMENT OR MATERIAL.

1. RACEWAY

- A. EMT: MAY BE USED FOR ALL BRANCH CIRCUIT WIRING IN AREAS ABOVE GRADE AND WITHIN THE THE BUILDING. ALL EMT SHALL BE GALVANIZED. ALL EMT FITTINGS SHALL BE STEEL WITH SET SCREWS.
- B. PVC: SHALL BE SCHEDULE 40 HIGH IMPACT, UL APPROVED, AND SHALL BE INSTALLED UNDERGROUND OR IN THE SLAB.
- C. RIGID CONDUIT: SHALL BE USED FOR ALL EXTERIOR INSTALLATION WHERE MECHANICAL DAMAGE IS POSSIBLE.

2. WIRE AND CABLE

- A. CONDUCTORS: SHALL BE COPPER. INSULATION SHALL BE TYPE THHN/THWN FOR ALL SIZES. MINIMUM SIZE WIRE NO. 12, CONDUCTORS NO. 10 AND LARGER ARE TO BE STRANDED. BRANCH CONDUIT OUTLETS SHALL BE CONNECTED AS INDICATED.
- B. COLOR CODES: CONDUCTORS SHALL BE COLOR CODED THROUGHOUT. SAME COLOR SHALL BE USED FOR BRANCH CIRCUIT WIRING OF A GIVEN PHASE. GROUNDED CONDUCTORS NO. 4 AWG AND LARGER MAY BE BLACK, BUT SHALL BE IDENTIFIED WITH COLORED TAPE IN JUNCTION BOXES, PULL BOXES, PANELS AND SERVICE EQUIPMENT.
 - 120/240V OR 120/208V SYSTEMS
 THREE WIRE CIRCUITS ONE BLACK, ONE RED AND ONE WHITE
 - FOUR WIRE CIRCUITS ONE BLACK, ONE RED, ONE WHITE, ONE BLUE

 277/480V SYSTEMS ONE BROWN ONE ORANGE ONE YELLOW
- 277/480V SYSTEMS —ONE BROWN, ONE ORANGE, ONE YELLOW, ONE GRAY
- CONTINUITY OF NEUTRALS OF MULTI-WIRED BRANCH CIRCUITS SHALL NOT BE MADE ON TERMINALS OF ANY DEVICE. THIS WILL ASSURE NO OPENING OF NEUTRAL IN REPLACEMENT OF DEVICE.
- #10 AND BELOW SCOTCHLOK OR EQUAL

• #8 AND LARGER — NOT ALLOWED

- A. OUTLET BOXES: SECTION WELDED GALVANIZED STAMPED STEEL FOR GANG SIZES REQUIRED. SECTIONAL BOXES WILL NOT BE ACCEPTABLE. BOXES LARGER THAN STANDARD SHALL BE PROVIDED IN ACCORDANCE WITH THE NATIONAL ELECTRICAL CODE WHERE NECESSARY TO PREVENT CROWDING OF WIRES.
- B. FLOOR BOXES: TO BE CARLON E971FB WITH E97ABR ADAPTER FOR CAST BRONZE COVER PLATES AS MANUFACTURED BY STEEL CITY.

4. WIRING DEVICES

- MOUNTING HEIGHTS:

 SWITCHES AT 4'0" OR AS NOTED
- RECEPTACLES AT 18" OR AS NOTED, COORD WITH ARCH
- TELEPHONE OUTLETS AT 18" OR AS NOTED

 B. WALL SWITCHES: SHALL BE CONTRACTOR GRADE, QUIET—TYPE, HIGH
 PERFORMANCE SWITCHES RATED AT 15A.277V. COLOR AND SWITCH PLATES
- AS DIRECTED BY THE OWNER/DECORATOR.

 RECEPTACLES: SEE GENERAL NOTES ON THIS SHEET FOR REQUIREMENTS.
- D. POWER OUTLETS: LEVITON OR SLATER, TYPE AND SIZE AS NOTED.

 E. DIMMER SWITCHES: SHALL BE EQUAL TO LUTRON #N 1500 ML SLIDE DIMMER WITH TOUCH BUTTON ON/OFF SWITCH WITH LUTRON #N SML FOR THREE WAY CONTROL. LOW VOLTAGE DIMMERS SHALL BE NOVA SERIES,

LOAD COORDINATED AS REQUIRED. 5 DISCONNECT SWITCHES

- DISCONNECT SWITCHES
 SHALL BE FURNISHED WITH ENCLOSURES AS REQUIRED BY EXPOSURES EITHER
 NEMA 1 OR 3R AND SHALL BE HORSEPOWER RATED, HEAVY DUTY WITH
- FUSES AS NOTED.

 B. NON-FUSIBLE DISCONNECT SWITCHES: SHALL BE PROVIDED FOR ALL MOTORS LOCATED OUT OF SIGHT OF MOTOR CONTROLLER AND WHERE INDICATED ON THE DRAWINGS. DISCONNECT SWITCHES SHALL DISCONNECT ALL
- UNGROUNDED CONDUCTORS.

 C. FUSES: TO BE FURNISHED FOR FUSIBLE EQUIPMENT. MOTOR FUSES SHALL BE BUS FUSETRONS RATED BETWEEN 125 AND 150 PERCENT OF MOTOR NAME PLATE RATING. FURNISH EXTRA SET OF SPARE FUSES FOR EACH FUSED DISCONNECT INSTALLED. SPARE FUSES TO BE PLACED WITHIN A FUSE

CABINET LOCATED IN THE ELECTRIC ROOM. PANELBOARD, LOADCENTER

- A. LOADCENTERS SHALL BE AS NOTED ON PLANS WITH COVER AND TYPEWRITTEN DIRECTORY INSIDE OF COVER. PANELBOARDS SHALL BE THE PRODUCT OF CUTLER—HAMMER OR SQUARE D.
- 7. LIGHTING FIXTURESA. UNLESS OTHERWISE NOTED, LIGHT FIXTURE


A. UNLESS OTHERWISE NOTED, LIGHT FIXTURES WILL BE FURNISHED AND INSTALLED AS INDICATED ON THE LIGHTING FIXTURE SCHEDULE FOR INSTALLATION BY THE ELECTRICAL CONTRACTOR.

8. IDENTIFICATION

- A. TAG ALL CONDUCTORS AND IDENTIFY MAJOR CONDUITS IN OR AT WIREWAYS, PANELS, PULLBOXES, SWITCHBOARDS, MOTOR CONTROLLERS, CABINETS AND SIMILAR ITEMS TO ASSIST IN FUTURE CIRCUIT TRACING. CONDUCTOR TAGS SHALL BE NONCONDUCTIVE.
- B. IDENTIFY ALL CIRCUITS AND EQUIPMENT TO CORRESPOND WITH THE PLANS AND SPECIFICATIONS.

C C	ПЕПП				CNIT	ΓD					
<u>30</u>	$\Box\Box\Box\Box$	LE OF	LUAI	UU							
PANELS: A											
MAIN: 125 AMP LUGS ONLY PANEL SPEC: SIEMENS TYPE "EQ-LOADCEN MOUNTING: FLUSH		APPROVED EC	QUIVALENT			VOLTAGE: 120/208V, 1ø, 3 WIRE FED FROM: METER AIC SYMM: SERIES RATED					
DESCRIPTION	TRIP CKT.	A PHASE KVA	C PHASE KVA	СКТ.	TRIP	DESCRIPTION					
	20 1 20 3	1.5 1.8	1.5 1.8	2	20	MINI SPLIT HVAC SYSTEM					
	20 3 20 5	<i>/////////////////////////////////////</i>	1.5 1.6	6	30	WATER HEATER					
	20 7		0.8 2.3	8	2	WATER HEATER					
)	20 9	1.5 1.8		2	20	MINI SPLIT HVAC SYSTEM					
	20 11 20 13	//////////////////////////////////////	1.5 1.8	4 14		SPACE					
	20 15		<i>/////////////////////////////////////</i>	16	_	SPACE					
	20 17	** _		18	_	SPACE					
LIGHTS & RECEPTS	- 19			20	_	SPACE					
LIGHTS & RECEPTS	- 21			22	_	SPACE					
LIGHTS & RECEPTS	- 23		- 1 -	24	_	SPACE					
**LIGHTING & RECEPTACLES @ 3 WATTS/	/SOFT	11.6	11.9	KVA	PER PH	ASE (NON-DIVERSIFIED)					
$600 \text{ SQFT } \times 3 \text{ VA} = 1.8 \text{ kVA}$	7 3 Q1 1	1.	.8	LTG	& RECE	PT LOAD KVA					
		25		TOTA	L NON-	DIVERSIFIED LOAD					
		21	.7	NON	DIVERSI	FIED LOAD LESS HVAC LOADS					
		10	0.0			© 100%					
		4.			AINDER @						
		3.				ASE LARGEST (HVAC)					
		18				SIFIED KVA					
① PROVIDE ARC-FAULT TYPE CIRCUIT BE	reaker	88	3.0	TOTA	L AMPS						

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	$\cup \sqcap L$	<u>. U C</u>	<u>lle of</u>	LUA	DC		
			PANELS: [3			
MAIN: 125 AMP LUGS ONLY P SPEC: SIEMENS TYPE "EQ-LOA MOUNTING: FLUSH		' OR	APPROVED EC	QUIVALENT			VOLTAGE: 120/208V, 10, 3 WIRE FED FROM: METER AIC SYMM: SERIES RATED
DESCRIPTION	TRIP	скт.	A PHASE KVA	C PHASE KVA	скт.	TRIP	DESCRIPTION
LIGHTS & RECEPTS (1	1.5 1.8		2	20	MINI SPLIT HVAC SYSTEM
LIGHTS & RECEPTS (3		1.5 1.8	4	2	WINT SI EIT TIVAG STOTEW
LIGHTS & RECEPTS (5	1.2 2.3		6	30	WATER HEATER
LIGHTS & RECEPTS (7	1.5 1.8	0.8 2.3	8	2	
LIGHTS & RECEPTS (LIGHTS & RECEPTS (11	1.5 1.8	//////////////////////////////////////	2	2 20	MINI SPLIT HVAC SYSTEM
LIGHTS & RECEPTS (13			14	-	SPACE
LIGHTS & RECEPTS (15		** _	16	_	SPACE
LIGHTS & RECEPTS (17	** _		18	_	SPACE
LIGHTS & RECEPTS	_	19		_ _	20	_	SPACE
LIGHTS & RECEPTS	_	21			22	-	SPACE
LIGHTS & RECEPTS	_	23			24	_	SPACE
**LIGHTING & RECEPTACLES @ 3 WA	TTS/SQF	Γ	11.6	11.9			ASE (NON-DIVERSIFIED)
$600 \text{ SQFT } \times 3 \text{ VA} = 1.8 \text{ kVA}$,		1.				PT LOAD KVA
				5.3			DIVERSIFIED LOAD
			21	• •			FIED LOAD LESS HVAC LOADS
			10				<u>@ 100%</u>
			3			AINDER (MASE LARGEST (HVAC)
				3.3			SIFIED KVA
				3.0		L AMPS	SII ILD IVA
① PROVIDE ARC-FAULT TYPE CIRCU	i breaki	-R		,,,,	LIOIA	IL MIII J	

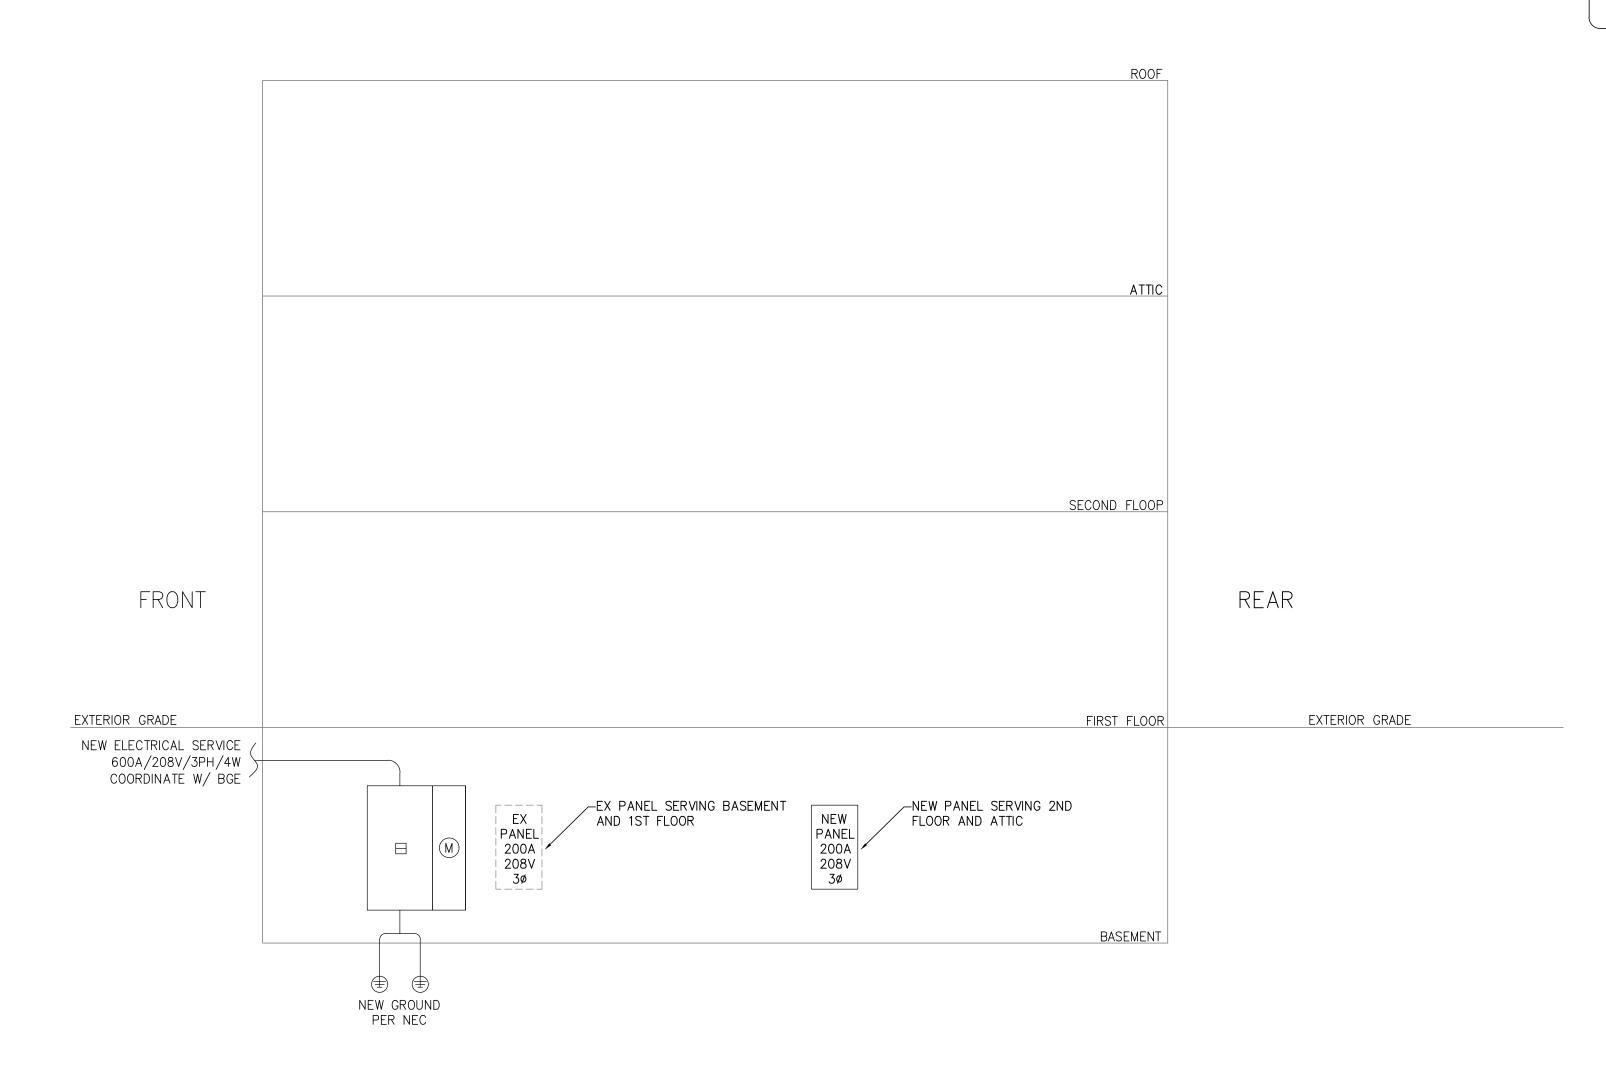



NOTES:

ELECTRICAL LEGEND

DESCRIPTION

SINGLE POLE TOGGLE SWITCH MOUNTED 4'-0" AFF

THREE WAY TOGGLE SWITCH MOUNTED 4'-0" AFF

DUPLEX RECEPTACLE 120V, 20A, 18" AFF, UON

DUPLEX RECEPTACLE 120V, 20A, 44" AFF, UON

PANEL, SIZE & VOLTAGE - SEE PANEL SCHEDULE.

DISCONNECT, VOLTAGE & SIZE AS NOTED.

SMOKE/CARBONMONOXIDE DETECTOR

ELECTRIC BASEBOARD HEATER

HOME RUN TO PANEL BOARD

EMERGENCY LIGHT FIXTURE

INTERNALLY ILLUMINATED EXIT SIGN

LED BATHROOM VANITY LIGHT FIXTURE

LED SURFACE MOUNTED LIGHT FIXTURE

EMERGENCY LIGHT/ EXIT SIGN COMBO FIXTURE

LED SURFACE MOUNTED RECESSED STYLE LIGHT FIXTURE

EXHAUST FAN

DUPLEX GFI RECEPTACLE 120V, 20A, 18" AFF, UON

KEYED LIGHT SWITCH MOUNTED 4'-0" AFF

CEILING MOUNTED OCCUPANCY SENSOR

WP= WEATHERPROOF COVER

SYMBOL

 \bigcirc



1010 EAST 43RD STREET, BALTIMORE, MD 212 ELECTRICAL SPECIFICATIONS

NO SCALE

DRAWING NO:

- . COORDINATE FIXTURE SCHEDULE WITH OWNER/ARCH FOR EXACT REQUIRED SPECS.
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- 4. EXISTING PIPING SHALL BE VERIFIED IN-FIELD.



NOTES:

KIDZ STUFF CHILD CARE CENTER 1010 EAST 43RD STREET, BALTIMORE, MD 2121

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ELECTRICAL

BASEMENT

SCALE:

1/4" = 1'-0"

E-2

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NOTES:

KIDZ STUFF CHILD CARE CENTER 1010 EAST 43RD STREET, BALTIMORE, MD 2121

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1ST FLOOR

CALE:

1/4" = 1'-0"

DRAWING NO

E-3

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NOTES:

KIDZ STUFF CHILD CARE CENTER 1010 EAST 43RD STREET, BALTIMORE, MD 2121

CALE:

1/4" = 1'-0"

2ND FLOOR

DRAWING NO:

E-4

- COORDINATE FIXTURE SCHEDULE WITH OWNER/ARCH FOR EXACT REQUIRED SPECS.
- 2. DRAWINGS ARE DIAGRAMMATICAL BY NATURE AND SHOULD NOT BE SCALED.
- 3. ALL CONTRACTORS PRIOR TO BID SUBMISSION PROCESS SHALL VISIT PROPOSED WORK SITE AND FIELD VERIFY ALL EXISTING CONDITIONS. ANY CONDITIONS THAT DIFFER FROM THAT SHOWN ON THIS PLAN SHALL BE REPORTED TO ARCHITECT/ENGINEER SO THAT NEW AND REVISED BID DRAWINGS OR INFORMATION MAY BE ISSUED. MODIFICATIONS TO SCOPE OF WORK WHICH RESULTS FROM CONTRACTORS NEGLECT TO VISIT WORK SITE PRIOR TO SUBMITTING BID, SHALL BE THE CONTRACTORS SOLE RESPONSIBILITY.
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NOTES:

STREET, BALTII - ELECTRICAL I 43RD 1010 EAST

PLANS

PLUMBING SPECIFICATIONS

1. SCOPE

A. PLUMBING CONTRACTOR SHALL FURNISH ALL LABOR, MATERIALS AND EQUIPMENT NECESSARY FOR THE COMPLETE INSTALLATION OF THE SANITARY SEWER SYSTEM (INCLUDING SOIL AND VENT PIPING), WATER SERVICE, CONNECTION TO WATER METER, TAP VALVES, BOXES, HOT AND COLD WATER SUPPLY SYSTEM, PLUMBING FITTINGS, FIXTURES AND TRIM; AND ALL RELATED FITTINGS AND CONTROLS.

B. WATER METER FEES BY OWNER.

C. ALL EXCAVATION AND BACKFILL AS REQUIRED FOR THIS PHASE OF CONSTRUCTION SHALL BE PART OF THIS CONTRACT.

2. CODES AND STANDARDS

ALL WORK, MATERIALS AND EQUIPMENT SUPPLIED AND INSTALLED UNDER THIS DIVISION SHALL COMPLY WITH THE LATEST EDITION OF THE IBC OR MBPS CODES AS AMENDED BY THE LOCAL GOVERNING BODY.

3. SUBMITTALS

SEE SCHEDULE ON DRAWINGS.

4. PERMITS AND INSPECTIONS

ALL PERMITS AND FEES FOR PERMITS AND INSPECTIONS SHALL BE PAID FOR BY THIS CONTRACTOR.

5. MATERIALS

A. SANITARY WASTE: PVC (WHERE ALLOWED BY CODE), DUCTILE IRON & CAST IRON, DWV TYPE PIPE AND FITTINGS.

a) BELOW FINISHED FIRST SLAB — SCHEDULE 40 DWV (FOAMCORE, CELLURCORE NOT ALLOWED)

b) ABOVE FINISHED FIRST FLOOR SLAB FOR SECOND FLOOR WASTE TO BE CAST IRON "NO-HUB"

B. ROOF DRAINS: PVC (WHERE ALLOWED BY CODE),
DUCTILE IRON & CAST IRON, DWV TYPE PIPE AND FITTINGS.

- a) BELOW FINISHED FIRST FLOOR SLAB SCHEDULE 40 DWV (FOAMCORE, CELLURCORE NOT ALLOWED)
- b) ABOVE FINISHED FIRST FLOOR SLAB TO BE
- CAST IRON "NO-HUB
 C. DOMESTIC WATER PIPING
- a) ABOVE GRADE TYPE "L" COPPER SWEATED OR FLANGED

D. VENT LINES TO BE SCHEDULE 40 PVC.

E. JOINTS TO BE WROUGHT OR CAST BRONZE. LEAD FREE SOLDER IS TO BE USED ON ALL JOINTS.

F. PROVIDE AND INSTALL PLUMBING FIXTURES AS SCHEDULED ON DRAWINGS. COMPLETE SYSTEM (FIXTURES AND EQUIPMENT) SHALL BE GIVEN AN IN-SERVICE TEST AFTER COMPLETION OF INSTALLATION.

G. UNDERGROUND VALVES SHALL BE INSTALLED IN PRECAST CONCRETE BOXES.

6. INSTALLATION

A. USE MANUFACTURER'S TEMPLATES. CAULK WHERE REQUIRED. PROVIDE BLOCKING FOR ALL FIXTURES AS REQUIRED. ALL WATER PIPING WITHIN THE BUILDING SHALL BE COPPER AND RUN CONTINUOUS ABOVE THE CEILING. NO JOINTS BELOW SLAB. ALL PIPING SHALL BE PROPERLY SUPPORTED WITH HANGERS OF COMPATIBLE MATERIAL AND ALL WATER PIPES PASSING THROUGH CONCRETE SHALL BE SLEEVED TO PREVENT CHEMICAL REACTIONS.

B. ALL HOT & RETURN WATER PIPING TO BE INSULATED.

MATERIAL TO BE 1" SECTIONAL GLASS FIBER WITH
FACTORY APPLIED, ALL PURPOSE, FIRE RETARDANT
JACKET. INSTALL PER MANUFACTURERS
RECOMMENDATIONS.

C. VERIFY INVERTS OF SEWER AND DRAINAGE CONNECTIONS BEFORE INSTALLING SEWER LINES. BUILDING DRAINAGE SYSTEM IS BASED ON 1/8"FT. MIN. SLOPE.

D. ALL WORK SHALL BE COORDINATED WITH OTHER TRADES TO AVOID INTERFERENCE WITH THE PROGRESS OF CONSTRUCTION.

E. HOSE BIBBS SHALL BE INSTALLED WHERE INDICATED ON THE DRAWINGS AND SHALL HAVE SEPARATE 3/4" MAIN FEED. HOSE BIBBS SHALL HAVE HOSE CONNECTION VACUUM BREAKER. FASTEN SECURELY TO WALL. INSTALL 18" ABOVE FINISHED SLAB.


7. CLEAN-UP

ON COMPLETION OF WORK, REMOVE ALL EXCESS MATERIAL, EQUIPMENT AND DEBRIS. POLISH ALL PLATED OR POLISHED FITTINGS. LEAVE WORK IN CLEAN CONDITION PER GENERAL CONDITIONS.

8. GUARANTE

THE PLUMBING CONTRACTOR SHALL DELIVER TO OWNER A WRITTEN GUARANTEE THAT THE PLUMBING WORK IS FREE FROM DEFECTS IN MATERIALS AND WORKMANSHIP FOR A PERIOD OF ONE YEAR, FROM THE DATE OF FINAL ACCEPTANCE, AND WILL REPAIR OR REPLACE ALL WORK WHICH BECOMES DEFECTIVE (NOT DUE TO ORDINARY USE) AT NO EXPENSE TO THE OWNER.

	P L	U N	I B	IN	G	FI	X T U R E S C H E D U L E				
TAG	FUNCTION		CONNECTION SIZES			REMARKS					
,,,,		CW	HW	SAN	VENT	GAS					
WC-1	FLUSH TANK WATER CLOSET	1/2"	_	3"	2"	_	COORDINATE WITH ARCH/OWNER FOR FIXTURE SPECS. 1.28 GPF MAX.				
L-1	LAVATORY SINK	1/2"	1/2"	2"	2"		COORDINATE WITH ARCH/OWNER FOR FIXTURE SPECS. 1.5 GPM MAX.				
S-1	SINK	1/2"	1/2"	2"	2"	1	COORDINATE WITH ARCH/OWNER FOR FIXTURE SPECS. 1.8 GPM MAX.				
WH-1	WATER HEATER	3/4"	3/4"	_	_	_	'A.O. SMITH' MODEL: ENT-40, WATER HEATER, 4.5 KW, 38 GALLON CAPACITY, 19" OUTER JACKET DIAMETER, TOP WATER CONNECTIONS.				

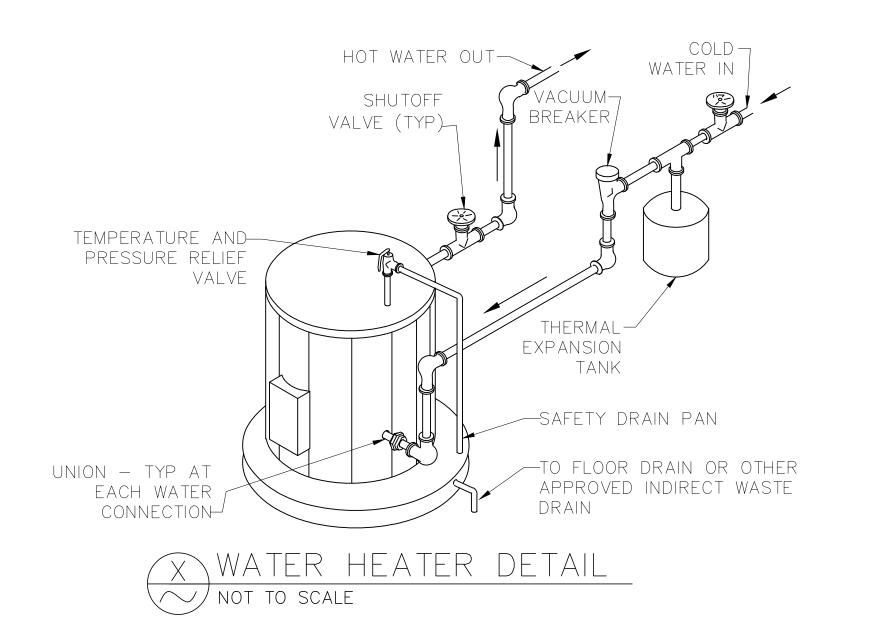

P L U M B I N G L E G E N D

(S-1)FIXTURE/EQUIPMENT TAG (SEE FIXTURE SCHEDULE) DOMESTIC COLD WATER PIPING _____ DOMESTIC HOT WATER PIPING DOMESTIC HOT WATER RECIRC. PIPING NATURAL GAS PIPING —— G——— G——— SANITARY WASTE PIPING SANITARY VENT PIPING _____ STORM WATER PIPING 0 TOILET FLANGE FLOOR DRAIN / AREA DRAIN ⊠FD/AD →I WCO WALL CLEAN OUT ∘FCO FLOOR CLEAN OUT ∘GCO GROUND CLEAN OUT PIPE UP PIPE DOWN \bigcirc DOMESTIC HOT WATER RECIRCULATION PUMP BACKFLOW PREVENTER \bowtie SHUTOFF VALVE CONNECTION POINT TO EXISTING



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SCALE:

DRAWING NO:

P-'

NO SCALE

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KIDZ STUFF CHILD CARE CENTER 1010 EAST 43RD STREET, BALTIMORE, MD 21212

PLUMBING

BASEMENT

SCALE:

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DRAWING NO:

P-2



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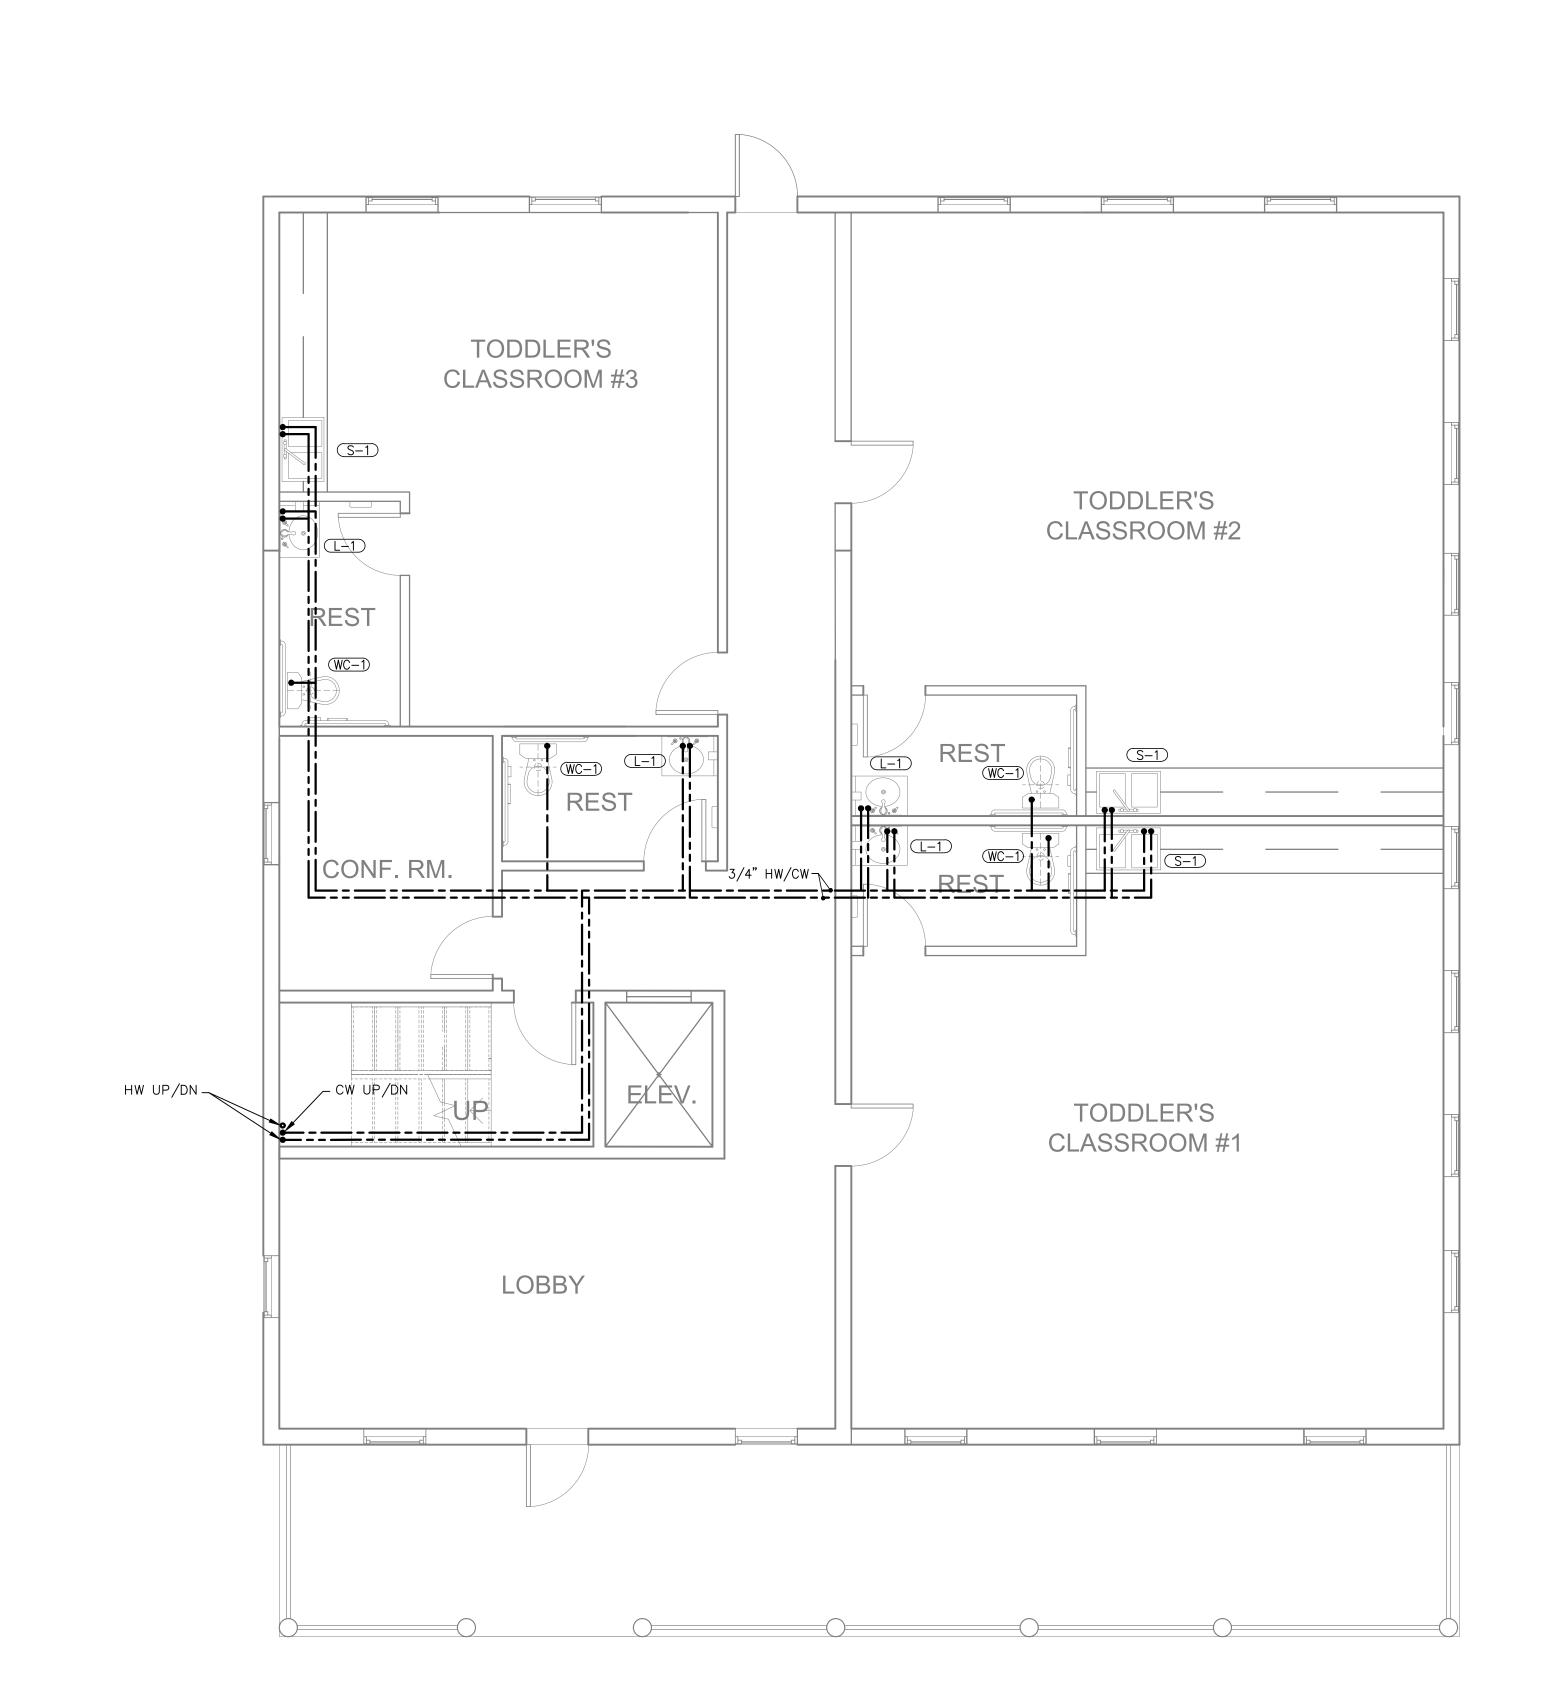
PLUMBING

SCALE:

1/4" = 1'-0"

DRAWING NO

P-3



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NOTES:

2 2 M BALTIMOR STREET 1010 EAST 43RD STR 2ND FLOOR

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PLUMBING

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PLAN

PLUMBING

CALE:

1/4" = 1'-0"

DRAWING NO:

P-5

