

6000 Metro LLC

6000 Metro Drive, Baltimore, MD 21215 [24ct FOC Lateral]

(Developer's Agreement No. 1676)

INDEX

1 - COVER SHEET	6 - PARTIAL 1ST FLOO
2 - GENERAL NOTES & LEGEND	7 - BORE PROFILE (1)
3 - TYPICAL DETAILS	8 - BORE PROFILE (2)
4 - PROJECT SHEET (1)	9 - TRAFFIC CONTROL
5 - PROJECT SHEET (2)	

CONTACTS

MTA:

MTA (Bldg):

TIER 4:

PFD:

9 - TRAFFIC CONTROL

6 - PARTIAL 1ST FLOOR PLAN

GRAYSON MORRIS (Customer) (410) 805-8777 gmorris1@mta.maryland.gov

ROB OLYPHANT (Superintendent) (410) 454-7942 Fare Collection Maintenance

ALEX MILWID (Project Manager) (443) 223-0792 alex.milwid@tier4md.com

MATT HANES (Project Engineer) (484) 571-7751 mhanes@precisionfd.com

SCOPE of WORK

THIS PROJECT SHALL PROVIDE 6000 METRO DRIVE WITH A NEW CONDUIT PATH TO EXISTING MTA INFRASTRUCTURE ALONG THE WEST SIDE OF METRO DRIVE (EXISTING MTA HAND HOLE)

NEW UNDERGROUND CONDUIT SHALL BE PLACED BY MEANS OF DIRECTIONAL BORING FROM THE EXISTING **MTA** HAND HOLE TO THE PROPOSED POINT OF ENTRY (STORAGE ROOM) ABOVE GRADE

NEW PLENUM INNER-DUCT SHALL NAVIGATE TO THE PHONE ROOM & EXISTING RELAY RACK (CUSTOMER DEMARC)

(1) 24ct FIBER OPTIC CABLE SHALL BE PULLED FROM THE EXISTING MTA HAND HOLE TO THE 6000 METRO DRIVE FIRST FLOOR PHONE ROOM

EXISTING CUSTOMER CONDUIT SHALL BE UTILIZED FROM THE EXISTING MTA HAND HOLE TO 4701 MOUNT HOPE DRIVE (EXISTING HH)


NEW PROJECT ±2,030' TOTAL

*** Confidentiality Notice ***

The information contained in this drawing set may be legally privileged and/or confidential. If you are not an intended recipient, you are hereby notified that any dissemination, distribution, or copying of these drawings is strictly prohibited. If you have received this paperwork in error, please notify the sender and destroy it immediately. You should not retain, copy, use or disclose to any other person any part of this drawing set for any purpose.

I HEREBY CERTIFY THAT THESE DOCUMENTS WERE PREPARED OR APPROVED BY ME, AND THAT I AM A DULY LICENSED PROFESSIONAL ENGINEER UNDER THE LAWS OF THE STATE OF MARYLAND

LICENSE NO. <u>42786</u> EXPIRATION DATE //

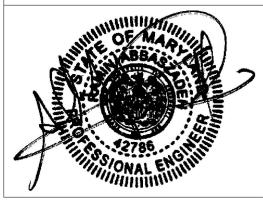

	_						
NGINEER:	WARD :	28					
	SECTION :	020	SECT.	APP.			
ATE: 06/07/19 LIC. NO. 42786	BLOCK :	4285					
	LOT :	014					
DESIGNED : <u>BRAD HANES (PFD)</u> DRAWN BY : MATT HANES (PFD)	BALTIMORE CITY REVIEW	R/W RELEASE	HIGH		BRIDGES	DRAINAGE	LIGHTING
JRAWN BI : MAIL HANES (PFD)	BY :						
CHECKED BY : GRAYSON MORRIS	DATE :						









CONDUIT

GRADE ESTABLISHMENT

Know what's below. Call before you dig.

6000 METRO LLC OWNER: 6000 METRO LLC

APPLICANT:

CITY OF BALTIMORE

DEVELOPER'S AGREEMENT No. 1676

6000 METRO LLC 6000 METRO DRIVE BALTIMORE, MD 21215

DATE: 10/16/2020 SCALE: NTS DRAWING: MTA-6000-MD SHEET: 1 OF 9 FILE REF.: 6000 Metro Drive, Baltimore, MD 21215_Rev 2_10.16.20

Director, Department of Transportation

Director, Department of Public Works

(1) CONTRACTOR SHALL NOTIFY THE FOLLOWING AT LEAST 14 DAYS PRIOR TO STARTING WORK:

a.	MISS UTILITY	800-257-7777

b. STREET LIGHT MAINTENANCE 410-396 1311 c. CONDUIT MAINTENANCE 410-396-1515

(2) CONTRACTOR MUST HAVE ALL EXISTING UTILITY LOCATIONS MARKED PRIOR TO DISTURBING THE GROUND - CALL YOUR LOCAL UTILITY MISS UTILITY AT LEAST 72 HOURS IN ADVANCE (3) THE CONTRACTOR IS RESPONSIBLE TO FIELD VERIFY ALL DIMENSIONS, QUANTITIES, AND EXISTING CONDITIONS PRIOR TO CONSTRUCTION - ALL DEPICTED UTILITIES ARE ASSUMED LOCATION - ALL DEPICTED UTILITIES ARE ASSUMED LOCATIONS OF NEW UNDERGROUND CONDUIT, VAULTS, AND MANHOLES SHALL BE DETERMINED UPON THE CURRENT LOCATIONS OF EXISTING UTILITIES - ROW LINES ARE APPROXIMATE - EX BALTIMORE CITY

(4) THE CONTRACTOR MUST HAVE AT LEAST ONE (1) COPY OF THE APPROVED PERMIT FROM THE APPROPRIATE AGENCIES, ON THE JOBSITE, AT ALL TIMES

(5) THE DUCT SECTION SHALL HAVE A MINIMUM COVER OF THREE FEET SIX INCHES (3'-6") UNDER ROADWAYS AND FOUR FEET (4'-0") UNDER SIDEWALKS. WHERE IT IS NOT POSSIBLE TO ADHE BECAUSE OF AN UNDERGROUND OBSTRUCTION, THE ENGINEER SHALL GIVE APPROVAL BEFORE THE CONFIGURATION OF THE DUCT SECTION OR DEPTH OF COVER IS REVISED - REFER TO BC SHALLOW LOCATIONS)

(6) ANY LANDSCAPING AND OR HARDSCAPING SHALL BE REPLACED TO EQUAL OR BETTER CONDITION THAN THAT WHICH EXISTED PRIOR TO WORK (7) PROJECT SITE WILL BE PROPERLY SECURED PRIOR TO THE END OF EACH DAY

(8) ALL WORK IS TO BE IN ACCORDANCE WITH ALL AUTHORITIES HAVING JURISDICTION IN THE WORK ZONE - ALL WORK SHALL COMPLY WITH APPLICABLE LOCAL, STATE, AND FEDERAL RE (9) CONTRACTORS ARE ADVISED TO CONTACT MTA FOR ANY ADDITIONAL INFORMATION OR CLARIFICATION CONCERNING SCOPE OF WORK OR THE REQUIREMENTS NECESSARY FOR PROJECT (10) CONTRACTOR IS RESPONSIBLE TO FIELD VERIFY ALL DIMENSIONS, QUANTITIES AND EXISTING CONDITIONS PRIOR TO CONSTRUCTION. IF A SIGNIFICANT CHANGE TO THE RUNNING LINE REPRESENTATIVE BEFORE PROCEEDING

(11) BEFORE CONSTRUCTION BEGINS, THE CONTRACTOR SHALL TAKE APPROPRIATE PRECAUTIONS TO AVOID ANY POTENTIAL OBSTRUCTIONS PRIOR TO PROCEEDING WITH WORK (12) CONTRACTOR SHALL NOT PROCEED WITH WORK UNTIL HE HAS RECEIVED A PURCHASE ORDER AND HAVE BEEN DIRECTED TO DO SO BY AN AUTHORIZED MTA REPRESENTATIVE

(13) CONTRACTOR SHALL NOT EXCEED THE PURCHASE ORDER VALUE WITHOUT AUTHORIZATION IN WRITING FROM THE APPROPRIATE MTA REPRESENTATIVE

(14) THE CONTRACTOR SHALL NOTIFY DPW (DOT CONDUIT MAINTENANCE - JEFF HARTMAN) A MINIMUM OF SEVENTY-TWO (72) HOURS (EXCLUDING WEEKENDS AND HOLIDAYS) PRIOR TO T OF ANY UNDERGROUND WORK

(15) THE REMOVAL AND DISPOSAL OF EXISTING PAVEMENT, SIDEWALKS, CURB AND COMBINATION CURB AND GUTTER, SHALL OCCUR WHEN WITHIN THE LIMITS OF ANY CLASS OF EXCAVATIO IN 02 41 13.16, (REMOVAL OF EXISTING PAVEMENT, SIDEWALK, PAVED DITCHES, CURB OR COMBINATION CURB AND GUTTER) (16) THE CONTRACTOR SHALL REMOVE PAVEMENT, SIDEWALK, CURB, ETC. OVER THE LINE OF THE PROPOSED ROUTE IN ACCORDANCE WITH THE REQUIREMENTS OF 32 01 30.1 0, (PATCH E SERVICES)

(17) IF A SIDEWALK(S) IS AFFECTED BY A UTILITY CUT, THE CONTRACTOR MUST RESTORE IT TO ITS ORIGINAL CONDITION WITH MATERIALS IDENTICAL TO THOSE OF THE ORIGINAL SIDEWAL REPLACED TO THE NEAREST EXISTING EXPANSION OR CONTRACTION JOINT ON EITHER SIDE OF THE UTILITY CUT

(18) ALL TRAFFIC CONTROL DEVICES SHALL BE IN PLACE PRIOR TO CONSTRUCTION. ALL CONSTRUCTION ZONES SHALL BE CLEAR OF SUCH DEVICES UPON COMPLETION - PROPER PEDESTRIA MAINTAINED AT ALL TIMES

(19) AS-BUILTS WILL BE REQUIRED FOR EACH PROJECT INCLUDING CABLE FOOTAGE SEQUENTIALS AT EVERY ACCESS POINT, SLACK LOOP, SPLICE LOCATION, POLE AND TERMINATION POINT NOTES OF ALL CHANGES IN DEPTHS, RUNNING LINES, MH/HH LOCATIONS, AND ANY OTHER APPLICABLE NOTES TO DEPICT THE WORK THAT WAS CONDUCTED AND BE SUBMITTED TO THE CI ALL MAJOR CHANGES NEED TO BE PRE-APPROVED BY AN AUTHORIZED MTA EMPLOYEE PRIOR TO STARTING THE WORK

CONDUIT SPECS

(20) ALL UNDERGROUND CONSTRUCTION SHALL AVOID TREE CANOPY DRIP LINES WHERE POSSIBLE

(21) LOCATE AND EXPOSE EXISTING CITY CONDUIT WITHIN THE PROPOSED ROUTE (IF NECESSARY)

(22) DO NOT BEND CABLE, IN HANDLING OR INSTALLATION, TO SMALLER RADII THAN MINIMUM RECOMMENDED BY MANUFACTURER

(23) INSTALL NONMETALLIC CONDUIT AND DUCT AS INDICATED ACCORDING TO MANUFACTURER'S WRITTEN INSTRUCTIONS

(24) MAKE JOINTS IN DUCTS AND FITTINGS WATERTIGHT ACCORDING TO MANUFACTURER'S INSTRUCTIONS. STAGGER COUPLINGS SO THOSE OF ADJACENT DUCTS DO NOT LIE IN THE SAME (25) DUCT ENTRANCES TO MANHOLES AND HANDHOLES: SPACE END BELLS APPROXIMATELY TEN INCHES (10.0") (TWO HUNDRED FIFTY (250) MM) ON CENTER FOR FIVE INCH (5.0") (ONE-HU VARIED PROPORTIONATELY FOR OTHER DUCT SIZES. CHANGE FROM REGULAR SPACING TO END BELL SPACING TEN FEET (10.0') (THREE (3) M) FROM THE END BELL WITHOUT REDUCING DL TRAP IN THE LINE. GROUT END BELLS INTO MANHOLE WALLS FROM BOTH SIDES TO PROVIDE WATERTIGHT ENTRANCES

(26) THE MINIMUM FOC BENDING RADIUS SHALL BE 36.0" (CONDUIT SWEEPS) (27) #10 TRACE WIRE IS REQUIRED FOR ALL UNDERGROUND INSTALLATIONS

(28) CONDUIT CAPS SHALL BE PLACED ON ALL VACANT DUCTS UNLESS CURRENTLY IN USE

(29) PLACE AT LEAST 50.0' OF FOC SLACK (STORAGE COIL) WITHIN EACH MANHOLE / VAULT / HANDHOLE

(30) THE REMOVAL AND STORAGE OF ALL UNDERGROWTH TO BE REPLACED IS THE RESPONSIBILITY OF THE CONTRACTOR

(31) NO BEND IN A CONDUIT RUN SHALL BE GREATER THAN 90 DEGREES AND ONLY TWO (2) 90 DEGREE BENDS SHALL BE ALLOWED PER RUN

(32) THE MAXIMUM DISTANCE BETWEEN MANHOLES / HAND HOLES SHALL NOT EXCEED 600.0'

HAND HOLE SPECS

33) HAND HOLES, HAND BOXES, AND MANHOLES SHALL BE INSTALLED FLUSH TO DRAIN WITH THE FINISHED GRADE

34) POLYMER CONCRETE HAND BOXES SHALL PROVIDE A WATERTIGHT SEAL ON THE HAND BOX AND BE SECURED WITH TWO PENTAGONAL BOLTS. THEY SHALL BE SKID RESISTANT AND COMPLY WITH ASTM C 1028. ALL HAND BOXES SHALL BE INSTALLED ON TWELVE INCHES (12") OF COMPACTED PEA GRAVEL WHICH IS TO EXTEND BEYOND THE BOX BY SIX INCHES (6") ON ALL SIDES. THE BOX SHALL BE SET TO FINISHED GRADE 35) CONDUIT SHALL BE PLACED UNDER EXISTING PAVEMENT BY JACKING, DRILLING, OR DIRECTIONAL BORING METHODS. PAVEMENT SHALL NOT BE DISTURBED WITHOUT PERMISSION FROM THE ENGINEER, EXCEPT AT POTHOLES, TO EXPOSE UTILITY LINES IN THE STREET. JACKING OR DRILLING PITS SHALL BE KEPT TWO FEET (2') CLEAR OF THE EDGE OF ANY TYPE OF PAVEMENT WHEREVER POSSIBLE. EXCESSIVE USE OF WATER, SUCH THAT PAVEMENT MIGHT BE UNDERMINED OR SOFTENED, WILL NOT BE PERMITTED. IN NO CASE SHALL ANY WATER USED IN THE WORK, BE ALLOWED TO ENTER ANY STORM DRAIN SYSTEM. JACKING PITS ADJACENT TO RAILROAD TRACKS SHALL BE CONSTRUCTED NOT LESS THAN TWELVE FEET (12') FROM THE CENTERLINE OF TRACK. WHEN THE JACKING PIT IS LEFT OVERNIGHT, IT SHALL BE COVERED WITH SUBSTANTIAL PLANKING

- ADDITIONAL NOTES -

(36) THE CONTRACTOR IS REQUIRED TO NOTIFY BGE AND BALTIMORE CITY STREET LIGHTING MAINTENANCE AT 410-396-4446 FOUR WEEKS PRIOR TO STARTING WORK.

(37) THE CONTRACTOR MUST PROTECT AND MAINTAIN EXISTING STREET LIGHTING AND CONDUIT/CABLE SYSTEM IN SERVICE. ANY INTERRUPTION OR DAMAGE TO STREET LIGHTING SERVICE, STREET LIGHT POLE OR CONDUIT/CABLE SHALL BE REPAIRED AS DIRECTED BY DOT STREET LIGHT MAINTENANCE AND BGE AT CONTRACTOR'S OWN EXPENSE

(38) IF THE CONTRACTOR UNCOVERS OR DAMAGES A STREET LIGHT CONDUIT OR CABLE DURING CONSTRUCTION, THE CONTRACTOR IS REQUIRED TO NOTIFY STREET LIGHTING MAINTENANCE AT 410- 396-4446 AND BGE IMMEDIATELY. STREET LIGHTING MAINTENANCE WOULD AFFECT REPAIRS OR DIRECT BGE TO MAKE SAFE CONDITIONS AND/OR REPLACE CONDUITS AND CABLE PRIOR TO RESUMING CONSTRUCTION. ALL SUCH REPAIRS SHALL BE MADE AT THE CONTRACTOR'S OWN EXPENSE.

(39) THE CONTRACTOR WOULD BE RESPONSIBLE TO PROVIDE TEMPORARY LIGHTING AS PER BALTIMORE CITY STANDARDS IF THE EXISTING LIGHTS CANNOT BE MAINTAINED IN SERVICE DURING CONSTRUCTION UNTIL PERMANENT LIGHTING ARE OPERATIONAL.

(40) THE CONTRACTOR IS REQUIRED TO CONTACT STREET LIGHTING MAINTENANCE FOR THE POLES AND LIGHT FIXTURES TO BE REMOVED AND SALVAGED AND TO COORDINATE DE-ENERGIZING AND RE-ENERGIZING THE LIGHT POLES BY BGE.

(41) THE DEVELOPERS AND CONTRACTOR WOULD BE RESPONSIBLE FOR THE TOTAL COST OF STREET LIGHTING WORK INCLUDING REQUIRED CONDUIT CONSTRUCTION AND BGE SERVICES TO DE-ENERGIZE AND ENERGIZE LIGHT POLES. (42) BEFORE CONTRACTOR CAN REMOVE EXISTING POLES, THE CONTRACTOR IS REQUIRED TO CONTACT STREET LIGHTING MAINTENANCE TO AUTHORIZE STREET LIGHTING WORK WITH BGE AND OBTAIN COST ESTIMATE FOR BGE TO DE-ENERGIZE STREET LIGHT POLES AND LIGHT FIXTURES TO BE REMOVED AND SALVAGED. THE CONTRACTOR WILL RECEIVE SECOND ESTIMATE FOR BGE TO ENERGIZE THE STREET LIGHT POLES AFTER INSTALLATION.

(43) THE CONTRACTOR IS REQUIRED TO CONTACT BGE AND DOT CONDUIT DIVISION 410-396-1515 FOR CONDUIT INSPECTION PRIOR TO FINAL PAVEMENT AND SIDEWALK WORK AND BGE CAN ENERGIZE THE LIGHT POLES. (44) THE DEVELOPERS AND CONTRACTOR WOULD BE RESPONSIBLE FOR THE TOTAL COST OF STREET LIGHTING WORK INCLUDING REMOVAL, INSTALLATION, REQUIRED CONDUIT CONSTRUCTION AND BGE SERVICES.

*** FOR ADDITIONAL DETAILS AND SPECIFICATIONS, PLEASE REFERENCE THE BALTIMORE CITY "GREEN BOOK" 2006 ***


https://generalservices.baltimorecity.gov/gs-major-projects/greenbook

CITY OF BALTIMORE DEPARTMENT OF PUBLIC WORKS SPECIFICATIONS

MATERIALS, HIGHWAYS, BRIDGES, UTILITIES, AND INCIDENTAL STRUCTURES (2006)

I HEREBY CERTIFY THAT THESE DOCUMENTS WERE PREPARED OR APPROVED BY ME, AND THAT I AM A DULY LICENSED PROFESSIONAL ENGINEER UNDER THE LAWS OF THE STATE OF MARYLAND

LICENSE NO. <u>42786</u> EXPIRATION DATE //

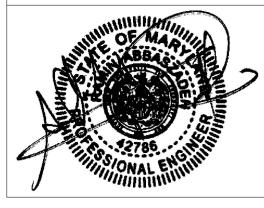

ENGINEER:	RAMIN ABBASZADEH, P.E.
DATE: 06/07	/19 LIC. NO. 42786
DESIGNED :	BRAD HANES (PFD)
DRAWN RY ·	MATT HANES (PED)

CHECKED BY : GRAYSON MORRIS

WARD :	28					
SECTION :	020	SECT.	APP.			
BLOCK :	4285					
LOT :	014					
BALTIMORE CITY REVIEW	R/W RELEASE	HIGHWAY DESIGN		BRIDGES	DRAINAGE	LIGHTING
BY :						
DATE :						

	SYMBOLS		LINES
	Ō	FIRE HYDRANT	W
E OF ANY CONSTRUCTION 1-800-257-7777	-DE-	STREET LIGHT	G T
CATIONS AND MUST BE VERIFIED. EXACT EXACT LOCATIONS ARE TO BE DETERMINED BY	\square	STORM DRAIN LID / STRUCTURE	E E I
DHERE TO THE MINIMUM COVER SPECIFIED BC STD 824.08 (PROTECTION SLAB FOR	S	SANITARY SEWER LID / STRUCTURE	SD
	(\top)	TELEPHONE LID / STRUCTURE	———— Р/L ———— Р ———— BSB ———— В
REGULATORY AGENCIES ECT COMPLETION	E	ELECTRIC LID / STRUCTURE	
IE IS NEEDED, PLEASE CONTACT YOUR MTA	(\vee)	WATER LID / STRUCTURE	xx
	wv O	WATER VALVE	
THE CONTRACTOR'S ANTICIPATED BEGINNING	WM ()	WATER METER	I
TION IS MET. THE WORK SHALL BE AS SPECIFIED	gv O	GAS VALVE	
H EXISTING PAVEMENT AND RESET UTILITY			
ALK. ALL SIDEWALKS SHALL BE REMOVED AND		STORM DRAIN INLET	
RIAN TRAFFIC ROUTES AND CLEARANCE MUST BE	C	SIGN (NO POWER)	
INT. CONTRACTOR SHOULD ALSO PROVIDE E CITY OF BALTIMORE, CONDUIT SECTION. NOTE:		SIGN (POWER)	
		SIGN (DISPLAY)	
		PROPOSED HAND HOLE	
		EXISTING HAND HOLE	
E PLANE HUNDRED TWENTY-FIVE (125) MM) DUCTS AND	#	PROPOSED FOC STORAGE COIL	
DUCT LINE SLOPE AND WITHOUT FORMING A		TREE / BUSH	
	<u>E</u>	HANDICAP PARKING	
	- ITEM DESCRIPTION - - LOCATION - - FIBER CT / TYPE - - SEQUENTIAL RECORD -	'AT-A-GLANCE' INFORMATION BOX	
		3D MODEL VIEWER (LINK) 'CLICKABLE' ICONS TO EXPLORE	

NOTE

INFORMATION SHOWN IN THIS DRAWING PERTAINING TO EXISTING CONDITIONS HAS BEEN OBTAINED FROM AVAILABLE BUILDING DRAWINGS, ENGINEERING RECORDS, OR GENERAL FIELD OBSERVATIONS AND MAY NOT INDICATE ACTUAL EXISTING CONDITIONS IN DETAIL OR DIMENSION. THE CONTRACTOR IS RESPONSIBLE FOR DETERMINING THE ACTUAL EXISTING CONDITIONS PRIOR TO FABRICATION OR PERFORMANCE OF ANY WORK. SHOULD CONDITIONS BE DISCOVERED THAT PREVENT EXECUTION OF THE WORK AS INDICATED, THE CONTRACTOR SHALL IMMEDIATELY NOTIFY EACH GOVERNING ENTITY IN WRITING AND AWAIT DIRECTION BEFORE PROCEEDING WITH THE WORK.

CONDUIT	SEDIMENT AND EROSION CONTROL	TRAFFIC ENGINEERING	WASTE WATER ENGINEERING	WATER ENGINEERING	SIGNAL ENGINEERING

GRADE ESTABLISHMENT

Know what's **below** Call before you dig.

CONSTRUCTION DETAILS

XISTING WATER	CSW
XISTING GAS	DIP
XISTING TELEPHONE	EMT
XISTING ELECTRIC	
XISTING SANITARY SEWER	EOP
XISTING STORM DRAIN	FOC
IGHT-OF-WAY	HDPE
ROPERTY LINE	
UILDING SETBACK	HH
XISTING UNDERGROUND CONDUIT	RCP
XISTING UNDERGROUND UTILITY	ROW
XISTING FENCE	
UILDING OUTLINE	SC
URB & GUTTER	STA.
ROPOSED UG CONDUIT w/ PROP. OSP FOC	UG
ROPOSED PLENUM ID w/ PROP. OSP FOC	WM
XISTING UG CONDUIT w/ PROP. OSP FOC	WV

SYMBOL DESCRIPTION CONCRETE SIDEWALK DUCTILE IRON PIPE EXTRUDED METAL TUBING EDGE OF PAVEMENT FIBER OPTIC CABLE HIGH DENSITY POLYETHYLENE HAND HOLE REINFORCED CONCRETE PIPE RIGHT-OF-WAY STORAGE COIL STATION UNDERGROUND WATER METER WATER VALVE

6000 METRO LLC

OWNER: 6000 METRO LLC APPLICANT:

CITY OF BALTIMORE


DEVELOPER'S AGREEMENT No. 1676

6000 METRO LLC 6000 METRO DRIVE BALTIMORE, MD 21215

DATE: 10/16/2020 SCALE: NTS SHEET: 2 OF 9 DRAWING: MTA-6000-MD FILE REF.: 6000 Metro Drive, Baltimore, MD 21215_Rev 2_10.16.20

Director, Department of Transportation

Director, Department of Public Works

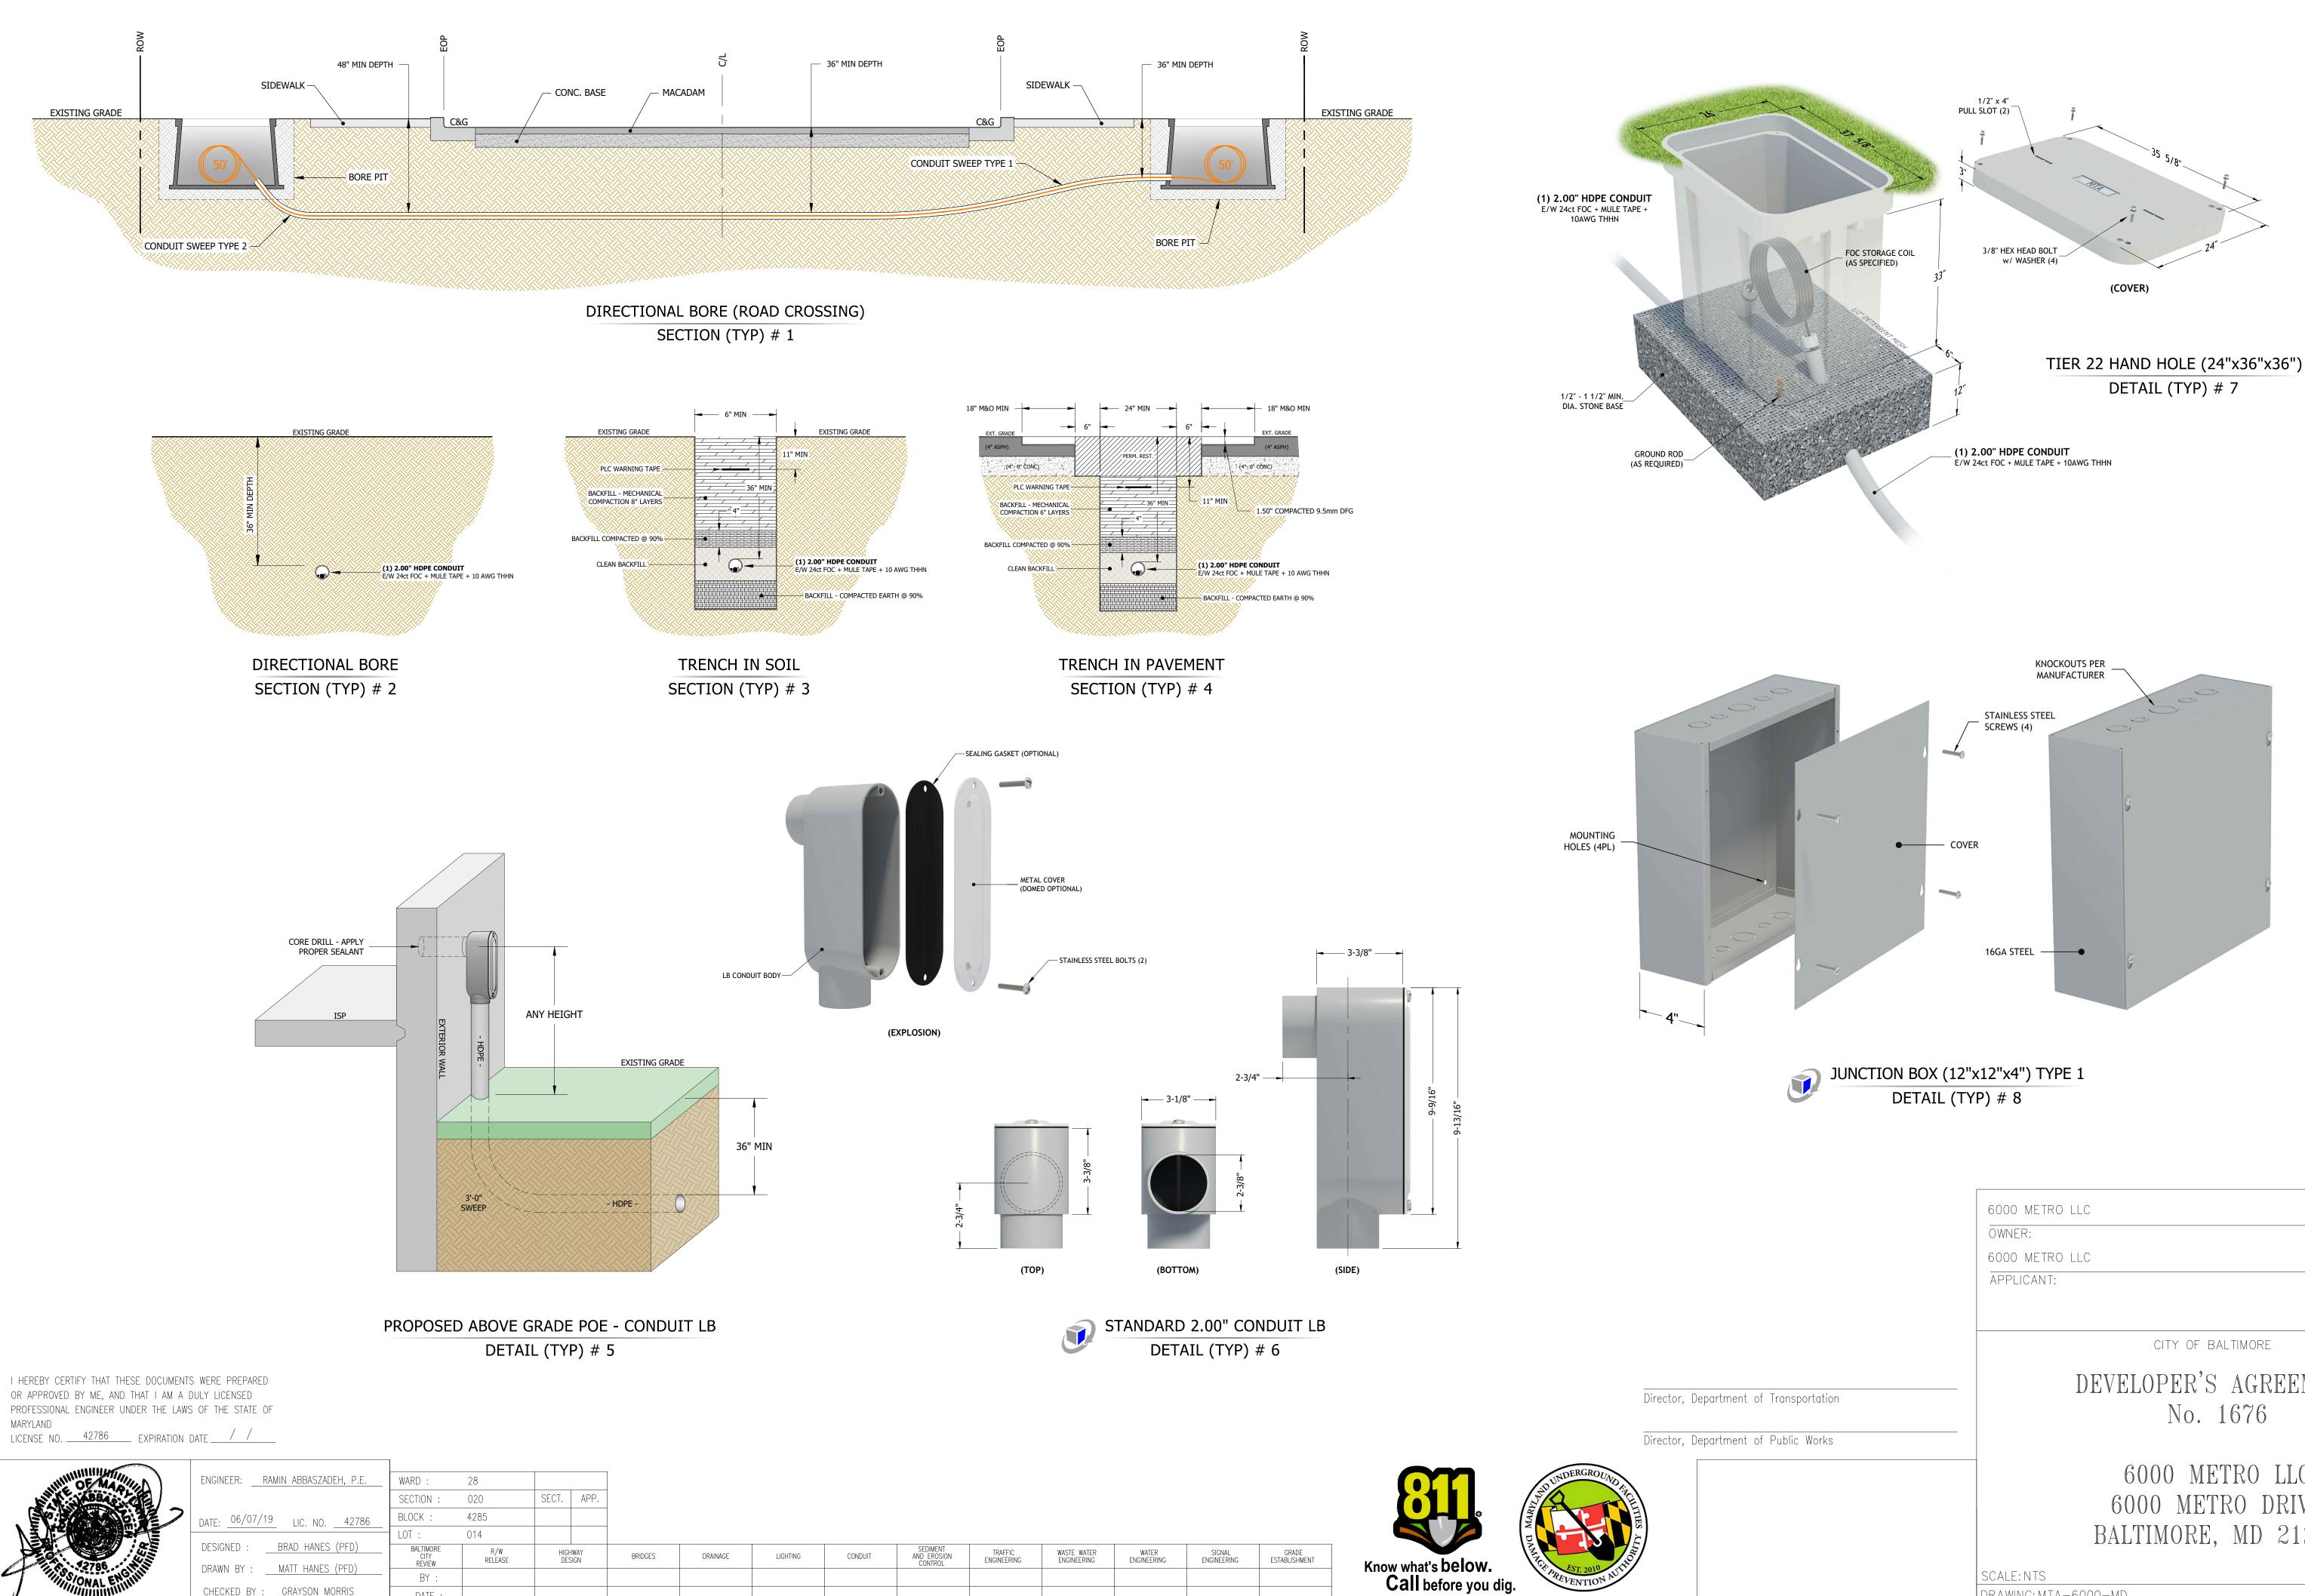

MARYLAND

DRAWN BY : _____MATT HANES (PFD) CHECKED BY : GRAYSON MORRIS


				_		
WARD :	28					
SECTION :	020	SECT.	APP.			
BLOCK :	4285					
 LOT :	014			-		
BALTIMORE CITY REVIEW	R/W RELEASE	HIGHWAY DESIGN		BRIDGES	DRAINAGE	LIGHTING
BY :						
DATE :						

DEVELOPER'S AGREEMENT

6000 METRO LLC 6000 METRO DRIVE BALTIMORE, MD 21215


SCALE: NTS DATE: 10/16/2020 SHEET: 3 OF 9 DRAWING: MTA-6000-MD FILE REF.: 6000 Metro Drive, Baltimore, MD 21215_Rev 2_10.16.20

FILE REF.: 6000 Metro Drive, Baltimore, MD 21215_Rev 2_10.16.20

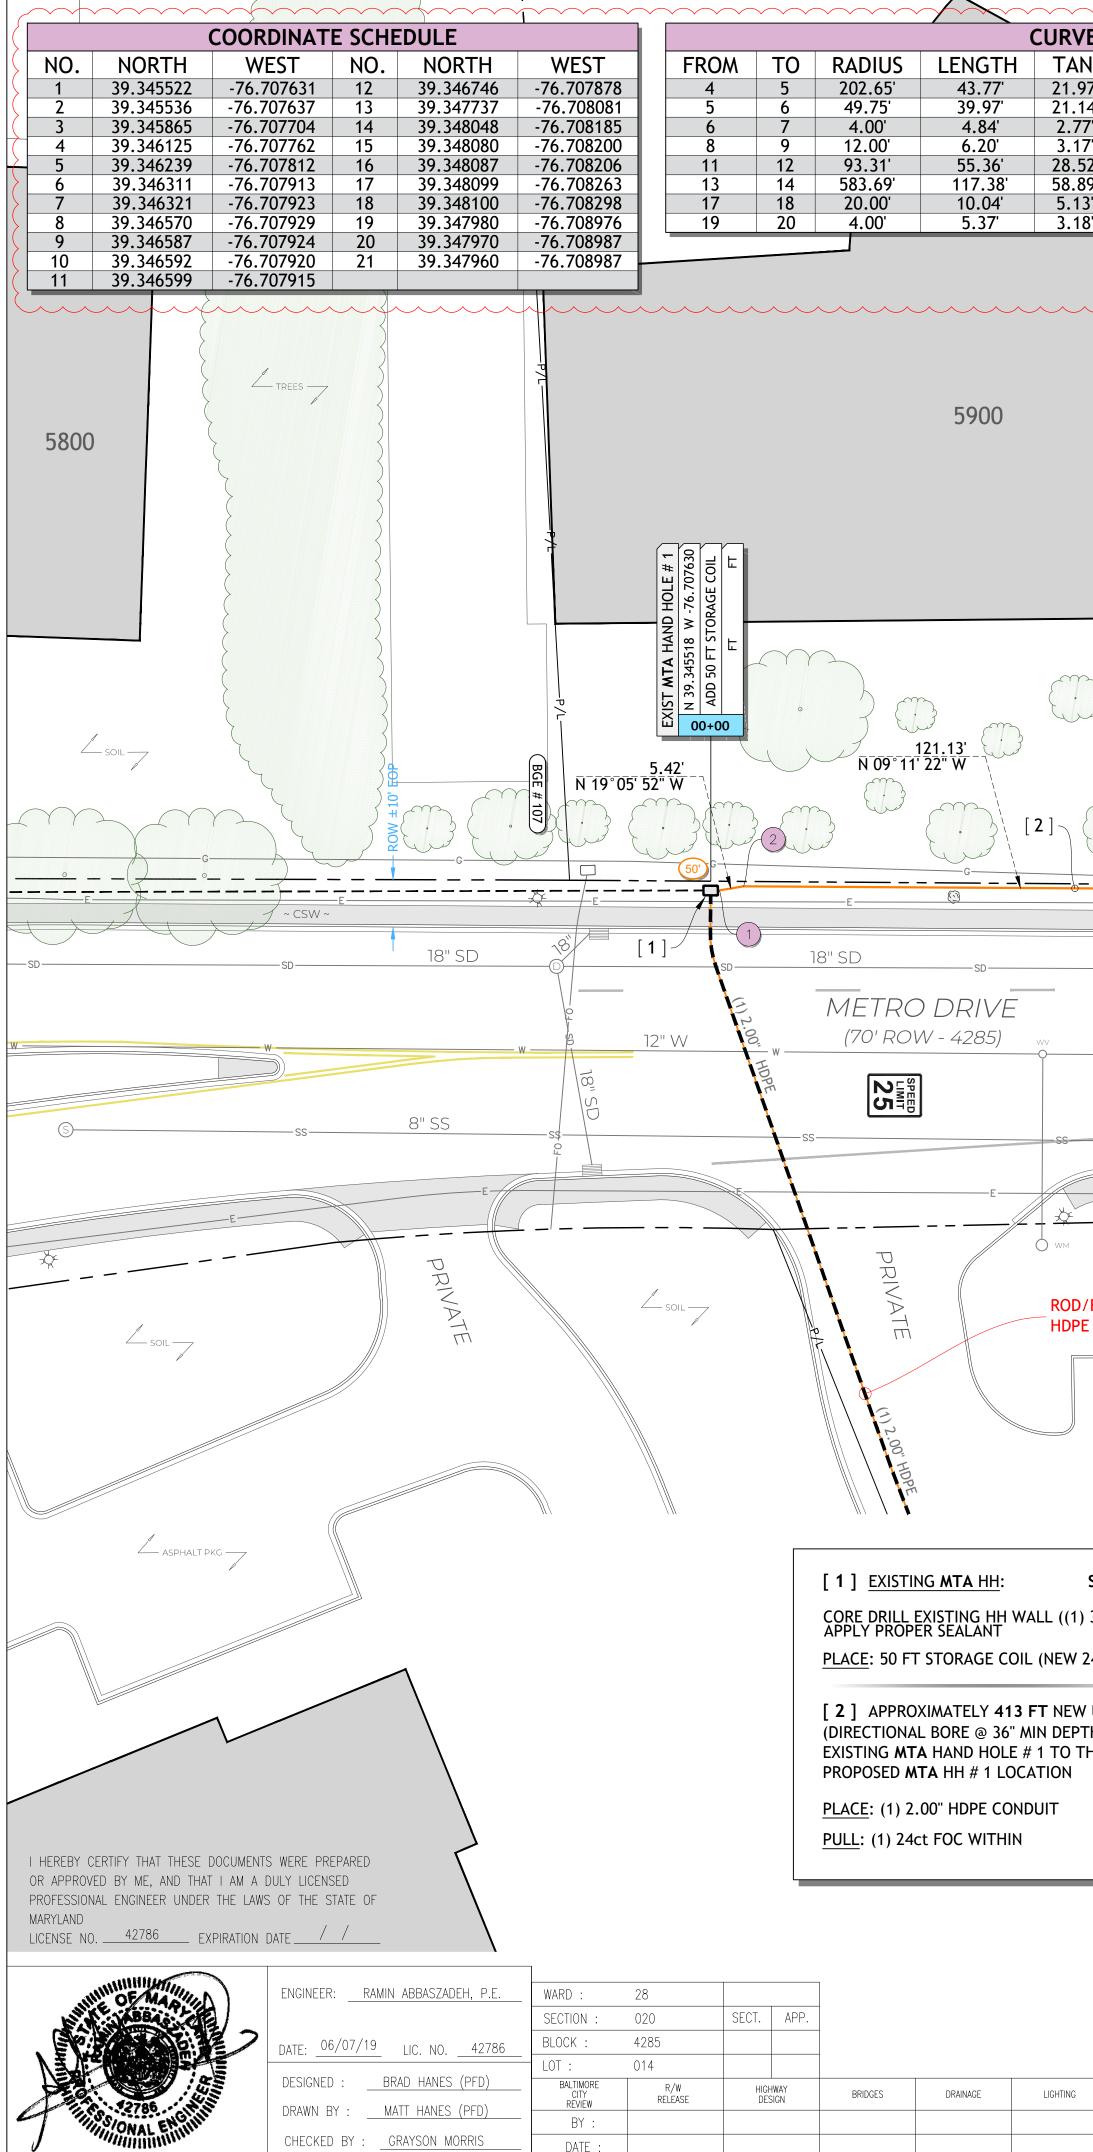



DATE :

								//	V			
VE N. .97' .14' 77' .52' .89' 13' 18'	DATA Δ 12°22'29" 46°02'16' 69°21'13" 29°37'11" 33°59'30" 11°31'20" 28°46'03" 76°59'23"	N 19° N 47° S 36° S 13° N 11 N 14° N 88°	BEARING ° 00' 31" W ° 40' 30" W ° 01' 01" E ° 28' 11" W ° 00' 54" E ° 39' 10" W ° 37' 36" W ° 29' 41" W	DISTANC 43.68' 38.91' 4.55' 6.14' 54.55' 117.18' 9.94' 4.98'							54 54	RON WOUNT
	ROW ±10' EOP				PRIVATE	ASPHALT PKG	BGE # 108			ROAL +14.5 EQ		ROW
E ~	CSW ~		vе	W		<u>96.24'</u> N 09°5		CATV CSW ~	инициинини	3		
			SD 18 SD ss	~ CSW ~	-E	W	SS	<u>SS</u>	W	~ CSW ~		
				700 FT OF EXI				Soil	$\overline{\langle}$			
	CONSTRU		<u>OTES</u>		ASPH4	ALT PKG						
1) 3.(A: 00+00 00" OD) & t OSP)	FUF FLL	RNISH & INSTA JSH WITH GRA	O <mark>MTA HH # 1</mark> : ALL NEW TIER ADE ORAGE COIL (1	22 HH (24"x)	36"x36")	LOCA	ONTRACTOR SH TION & DEPTH OR TO PROCEED	OF UNDERGRO	TO VERIFY EX DUND OBSTRU IDUIT INSTALI		
W UC PTH) THE	FROM	(DII THI PRC <u>PL</u> 4	RECTIONAL BO E PROPOSED A OPOSED MTA	ATELY 553 FT DRE @ 36" MIN MTA HH # 1 LC HH # 2 LOCATI HDPE CONDUI OC WITHIN	DEPTH) FRO DCATION TO ION			RESTORE G	RASS AREAS W HING OR SOLID *** NOTE *** IN THE AREA,	ITH SEEDING SODDING		
												Director, Depar Director, Depar
2	CONDUIT	SEDIMENT AND EROSION CONTROL	TRAFFIC ENGINEERING	WASTE WATER ENGINEERING	WATER ENGINEERING	SIGNAL ENGINEERING	GRADE ESTABLISHMENT		what's below before yo	TANNU MARK	UNDERGROUND EST. 2010 REVENTION AUTO	COLITIES ALINO.

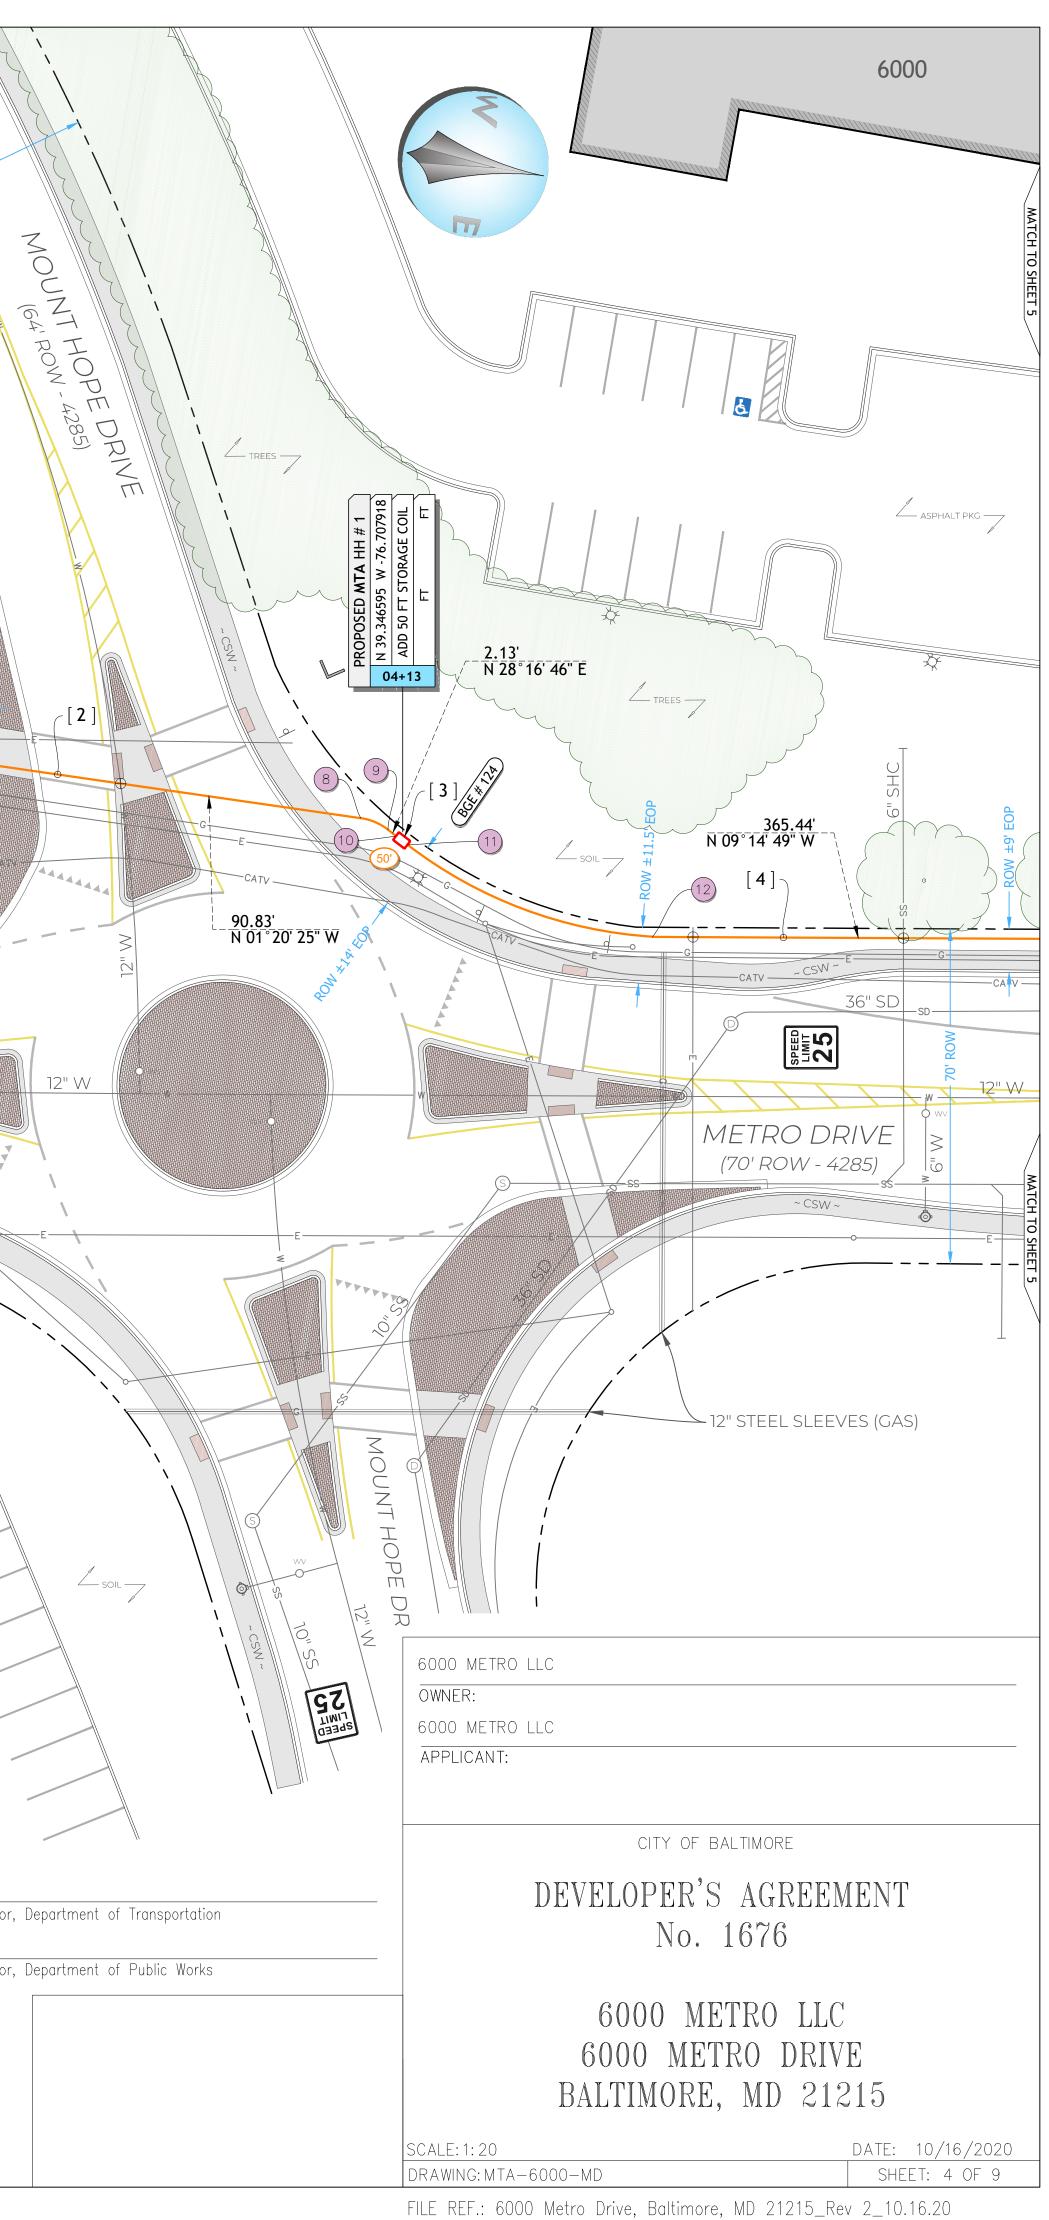





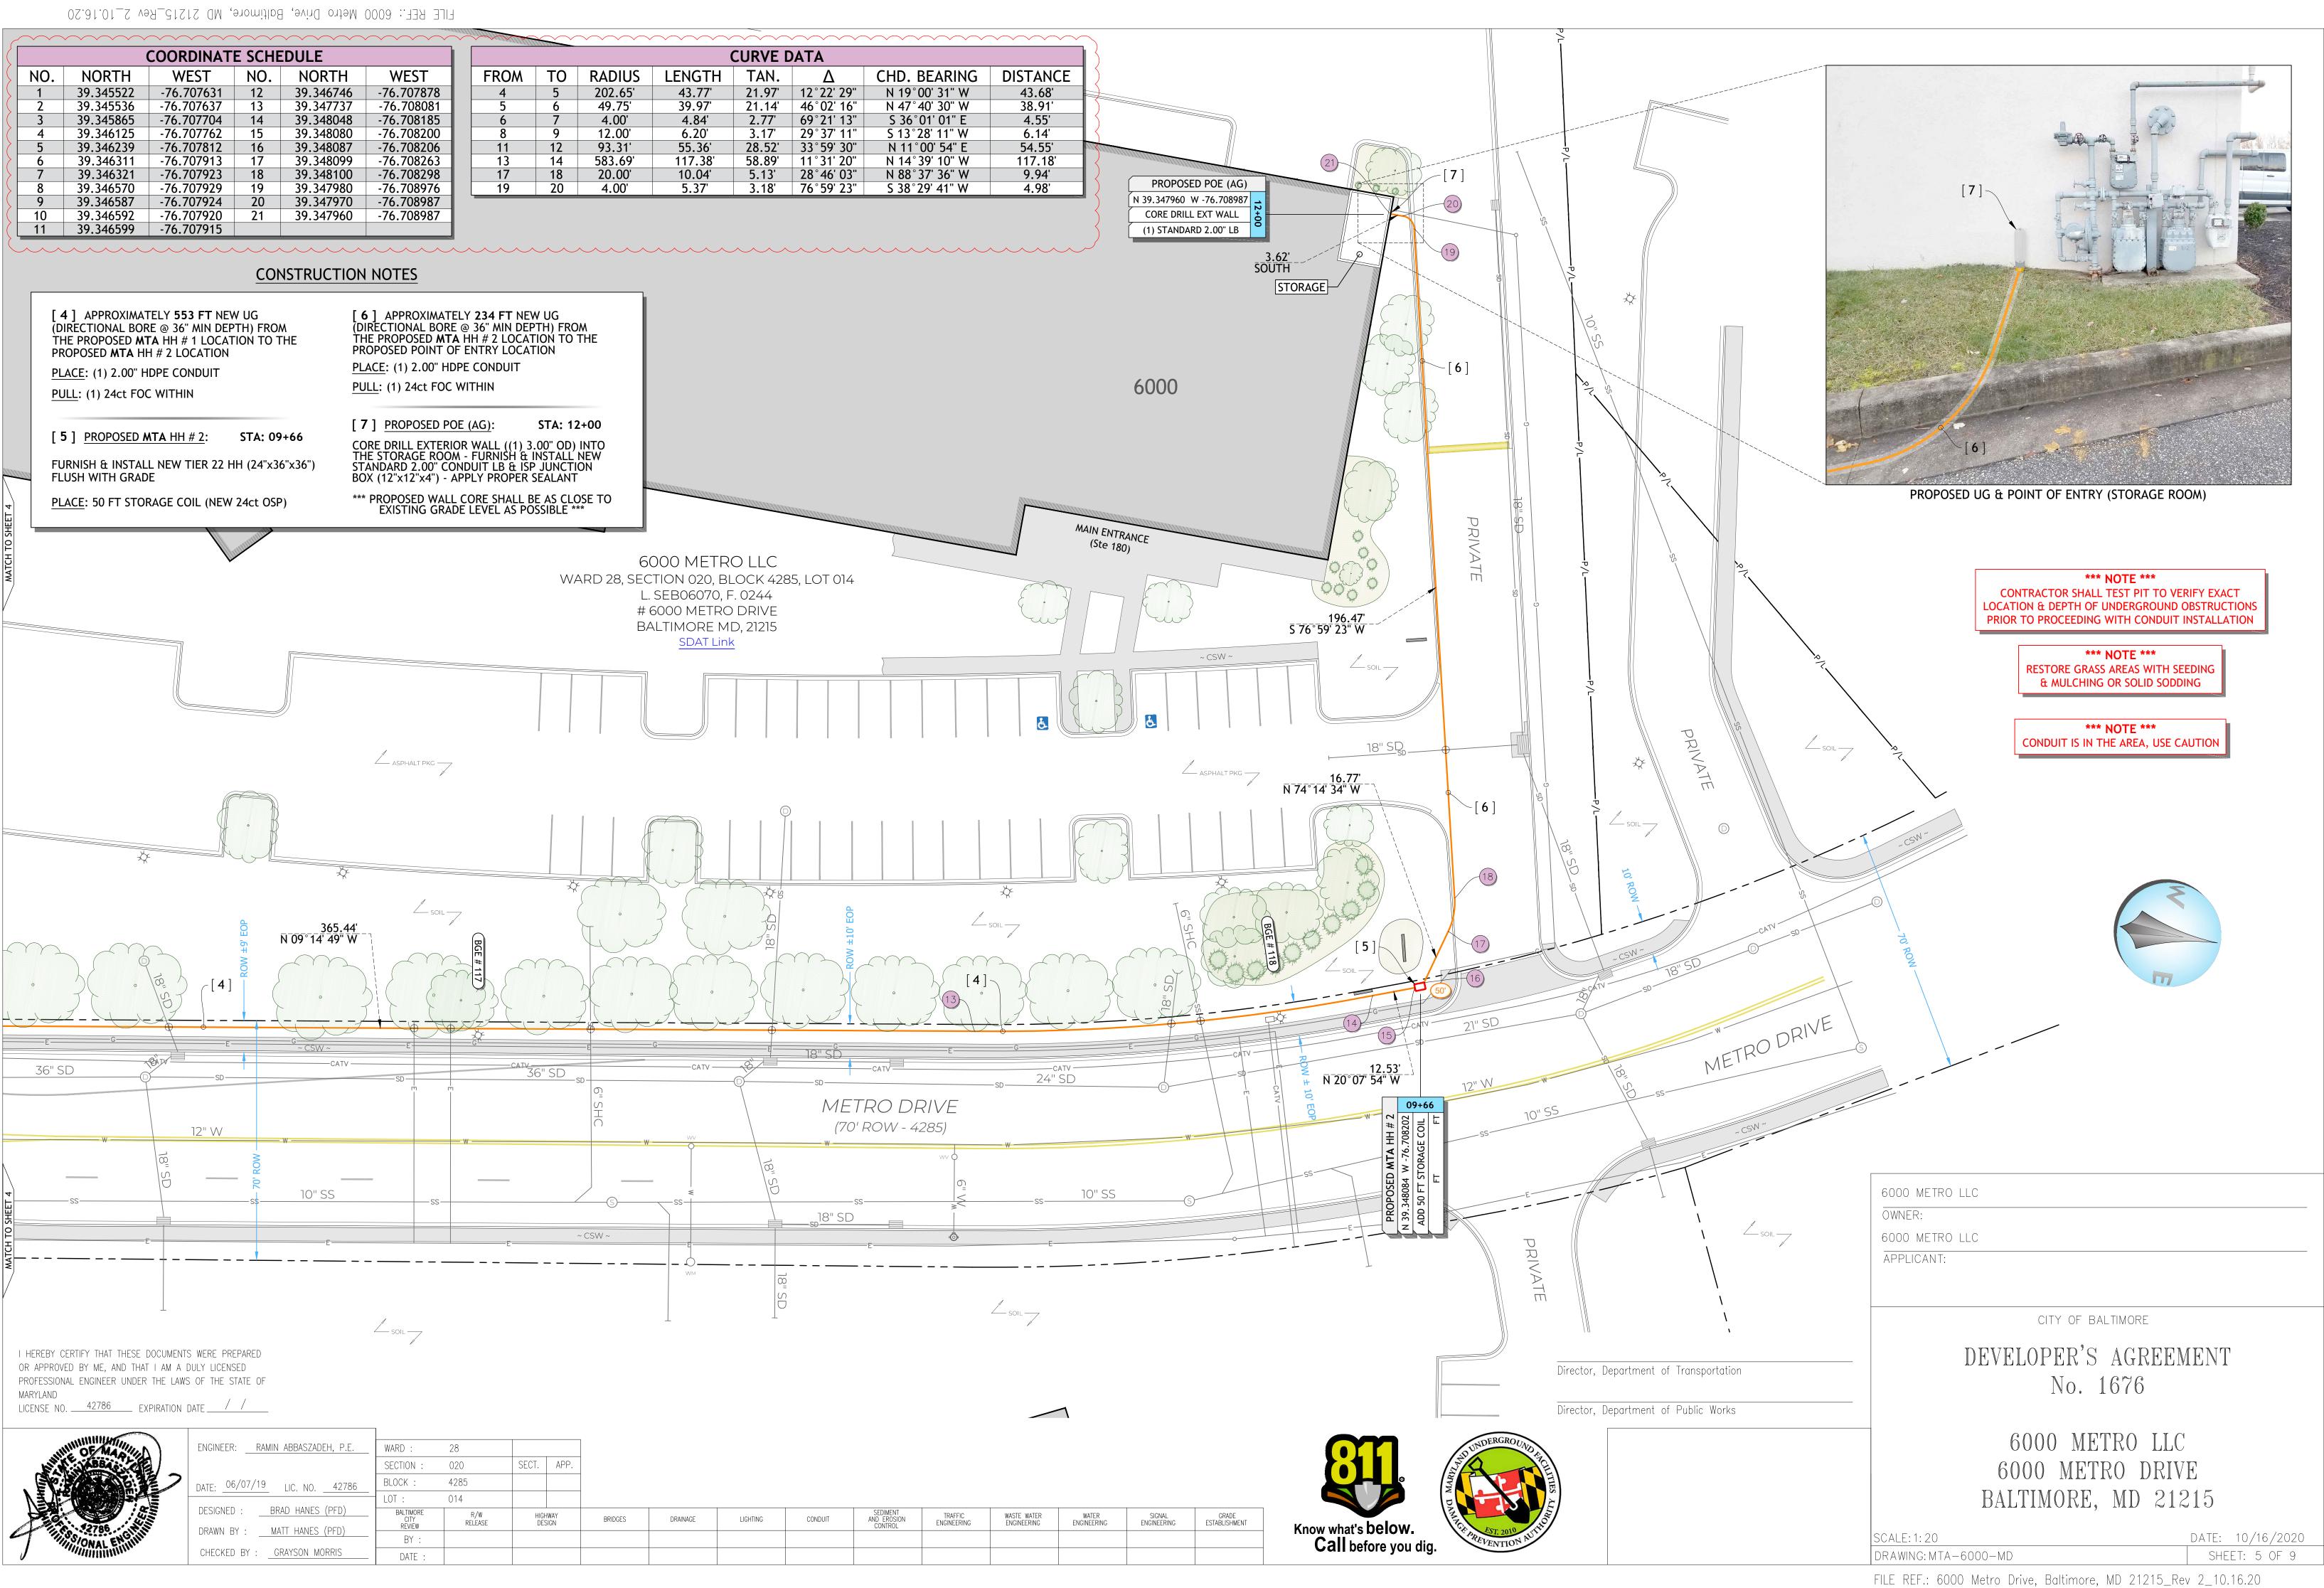

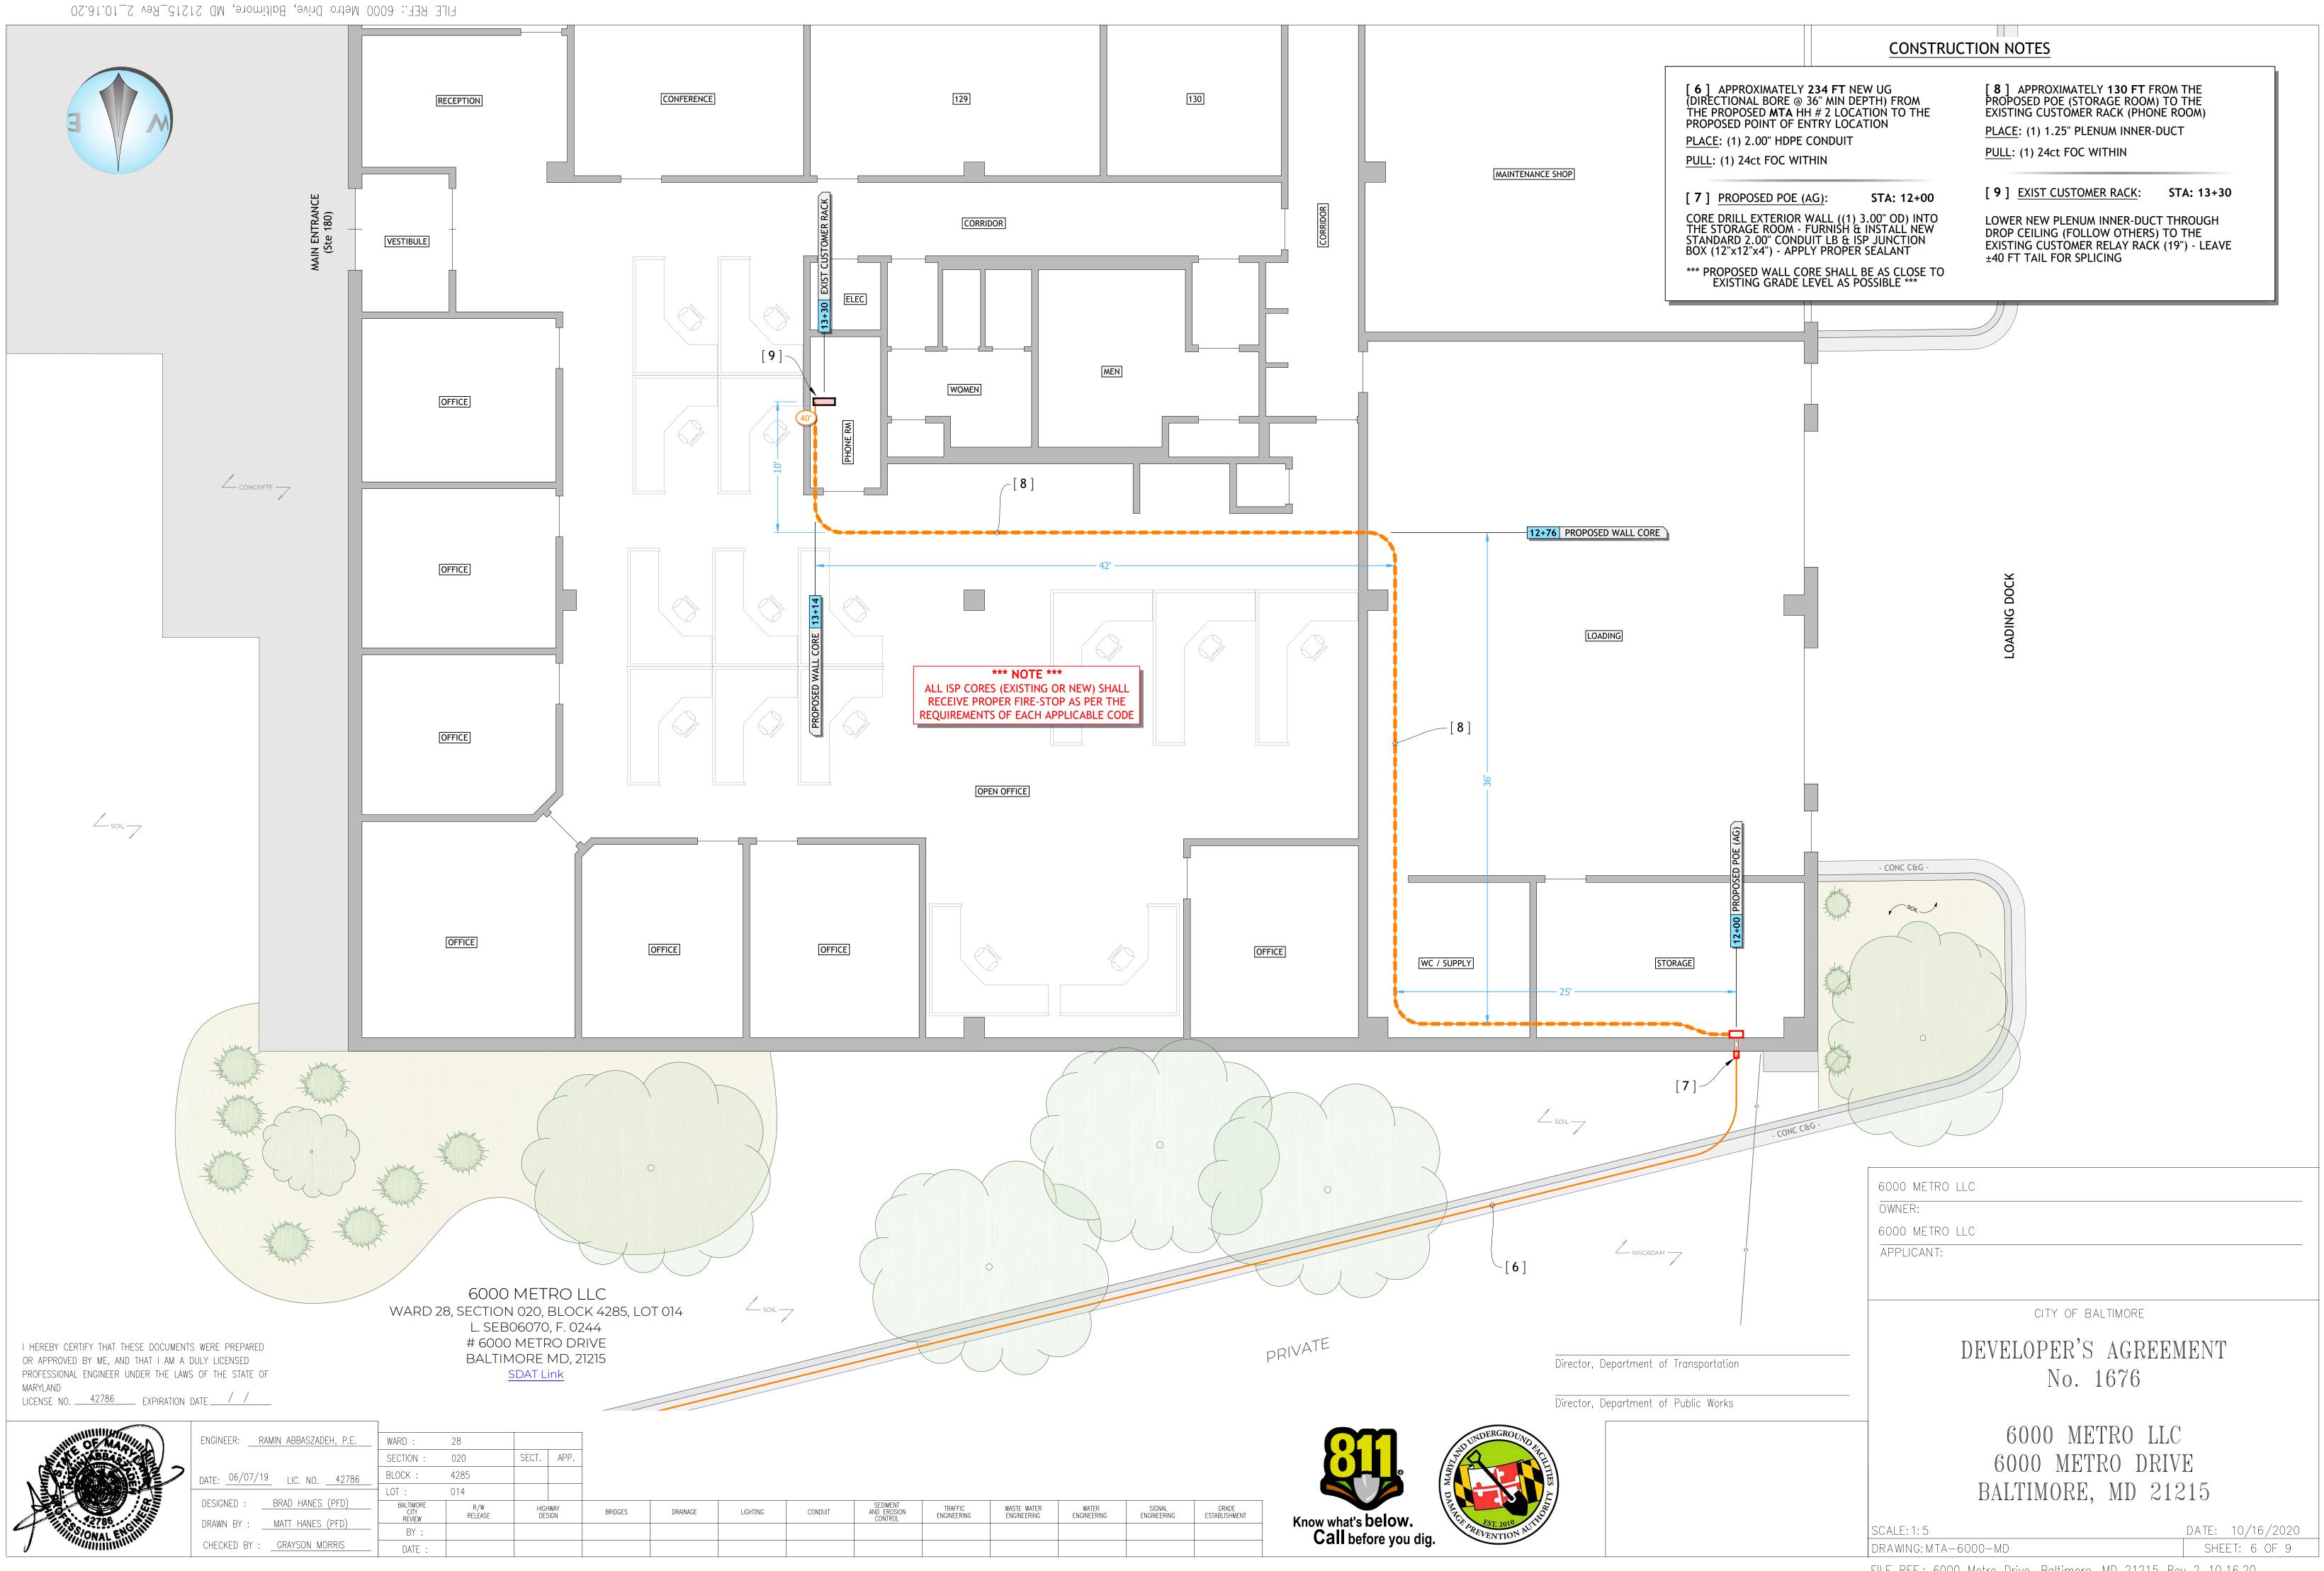

FILE REF.: 6000 Metro Drive, Baltimore, MD 21215_Rev 2_10.16.20

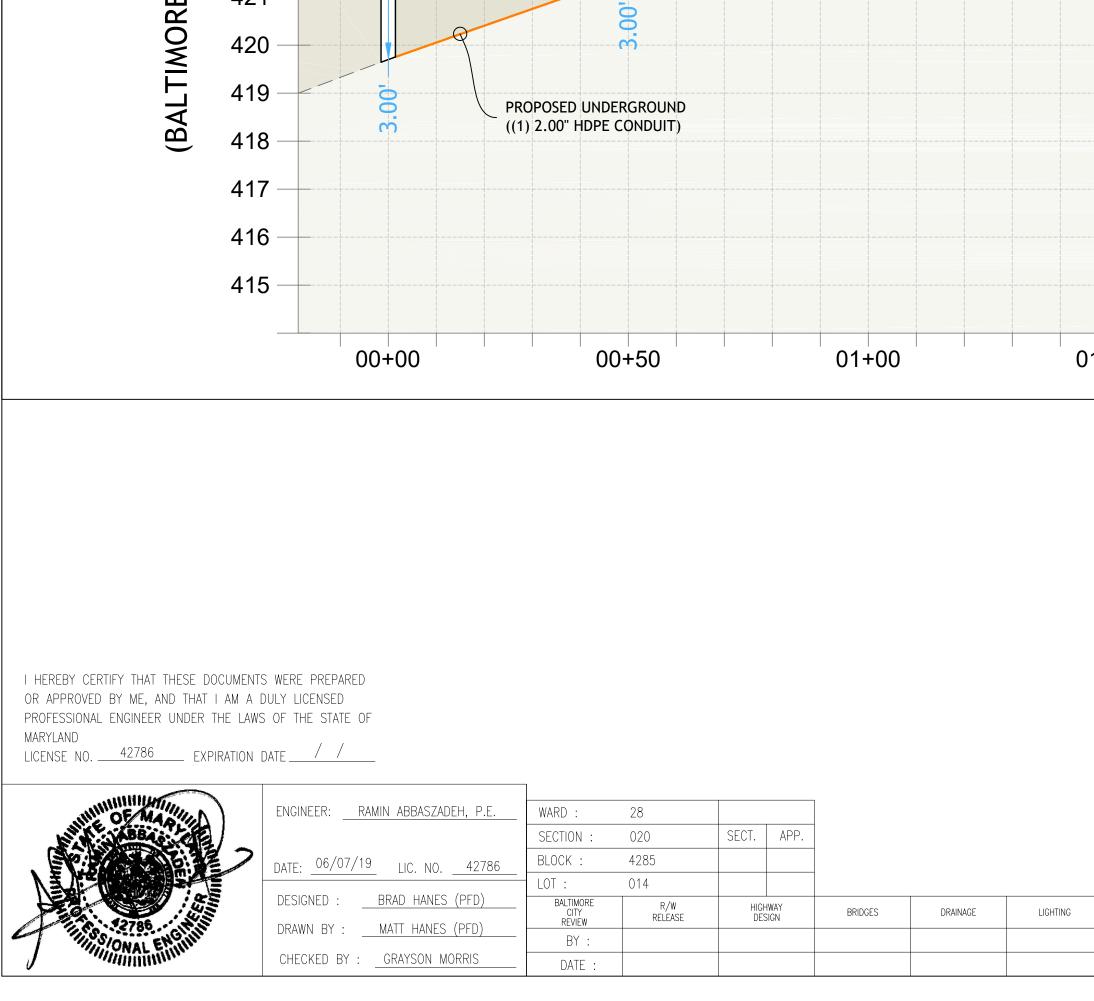

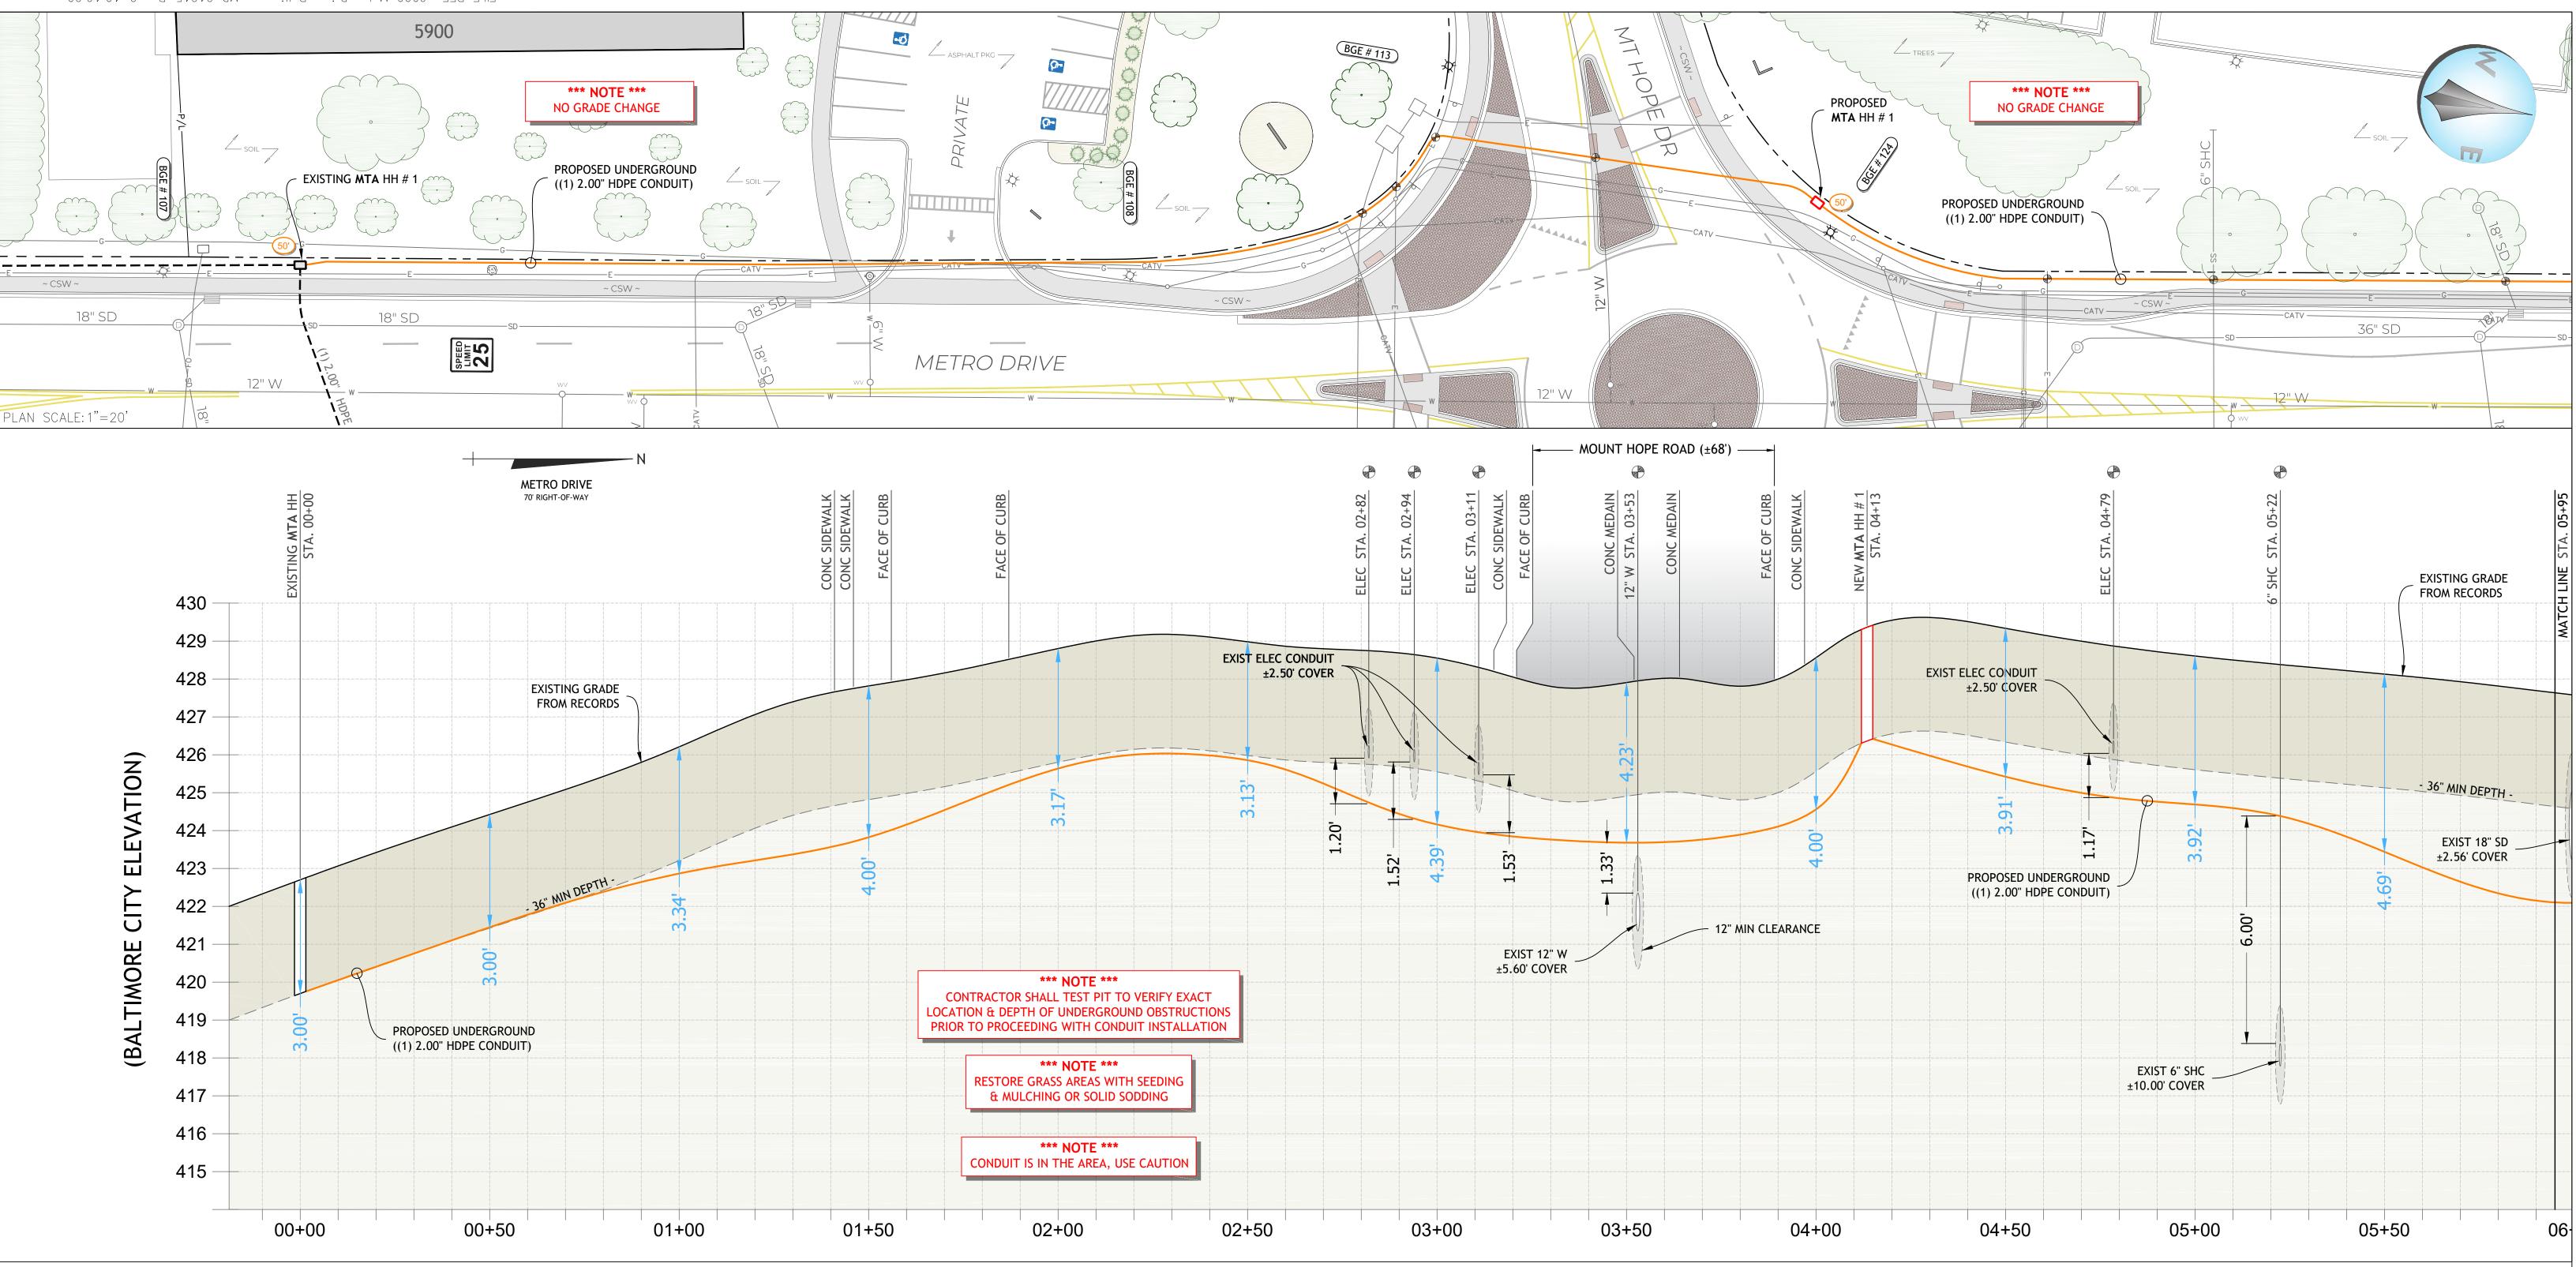

FILE REF.: 6000 Metro Drive, Baltimore, MD 21215_Rev 2_10.16.20

HORIZ. SCALE: 1"=20'VERT. SCALE: 1"=2'

Director, Department of Transportation

Director, Department of Public Works






WASTE WATER ENGINEERING GRADE ESTABLISHMENT 6000 METRO LLC OWNER: 6000 METRO LLC APPLICANT: CITY OF BALTIMORE DEVELOPER'S AGREEMENT No. 1676 6000 METRO LLC 6000 METRO DRIVE BALTIMORE, MD 21215 SCALE: NTS DATE: 10/16/2020 DRAWING: MTA-6000-MD SHEET: 7 OF 9 FILE REF.: 6000 Metro Drive, Baltimore, MD 21215_Rev 2_10.16.20

WINNING OF MAD	ENGINEER:	WARD :	28					
ABBAG: CE		SECTION :	020	SECT.	APP.			
	DATE: 06/07/19 LIC. NO. 42786	BLOCK :	4285					
		LOT :	014					
12785 N	DESIGNED : BRAD HANES (PFD)	BALTIMORE CITY REVIEW	R/W RELEASE	HIGHW/ DESIG		BRIDGES	DRAINAGE	LIGHTING
SONAL ENGINI	DRAWN BY : <u>MATT HANES (PFD)</u>	BY :						
	CHECKED BY : <u>GRAYSON MORRIS</u>	DATE :						

I HEREBY CERTIFY THAT THESE DOCUMENTS WERE PREPARED OR APPROVED BY ME, AND THAT I AM A DULY LICENSED PROFESSIONAL ENGINEER UNDER THE LAWS OF THE STATE OF

LICENSE NO. <u>42786</u> EXPIRATION DATE //

MARYLAND

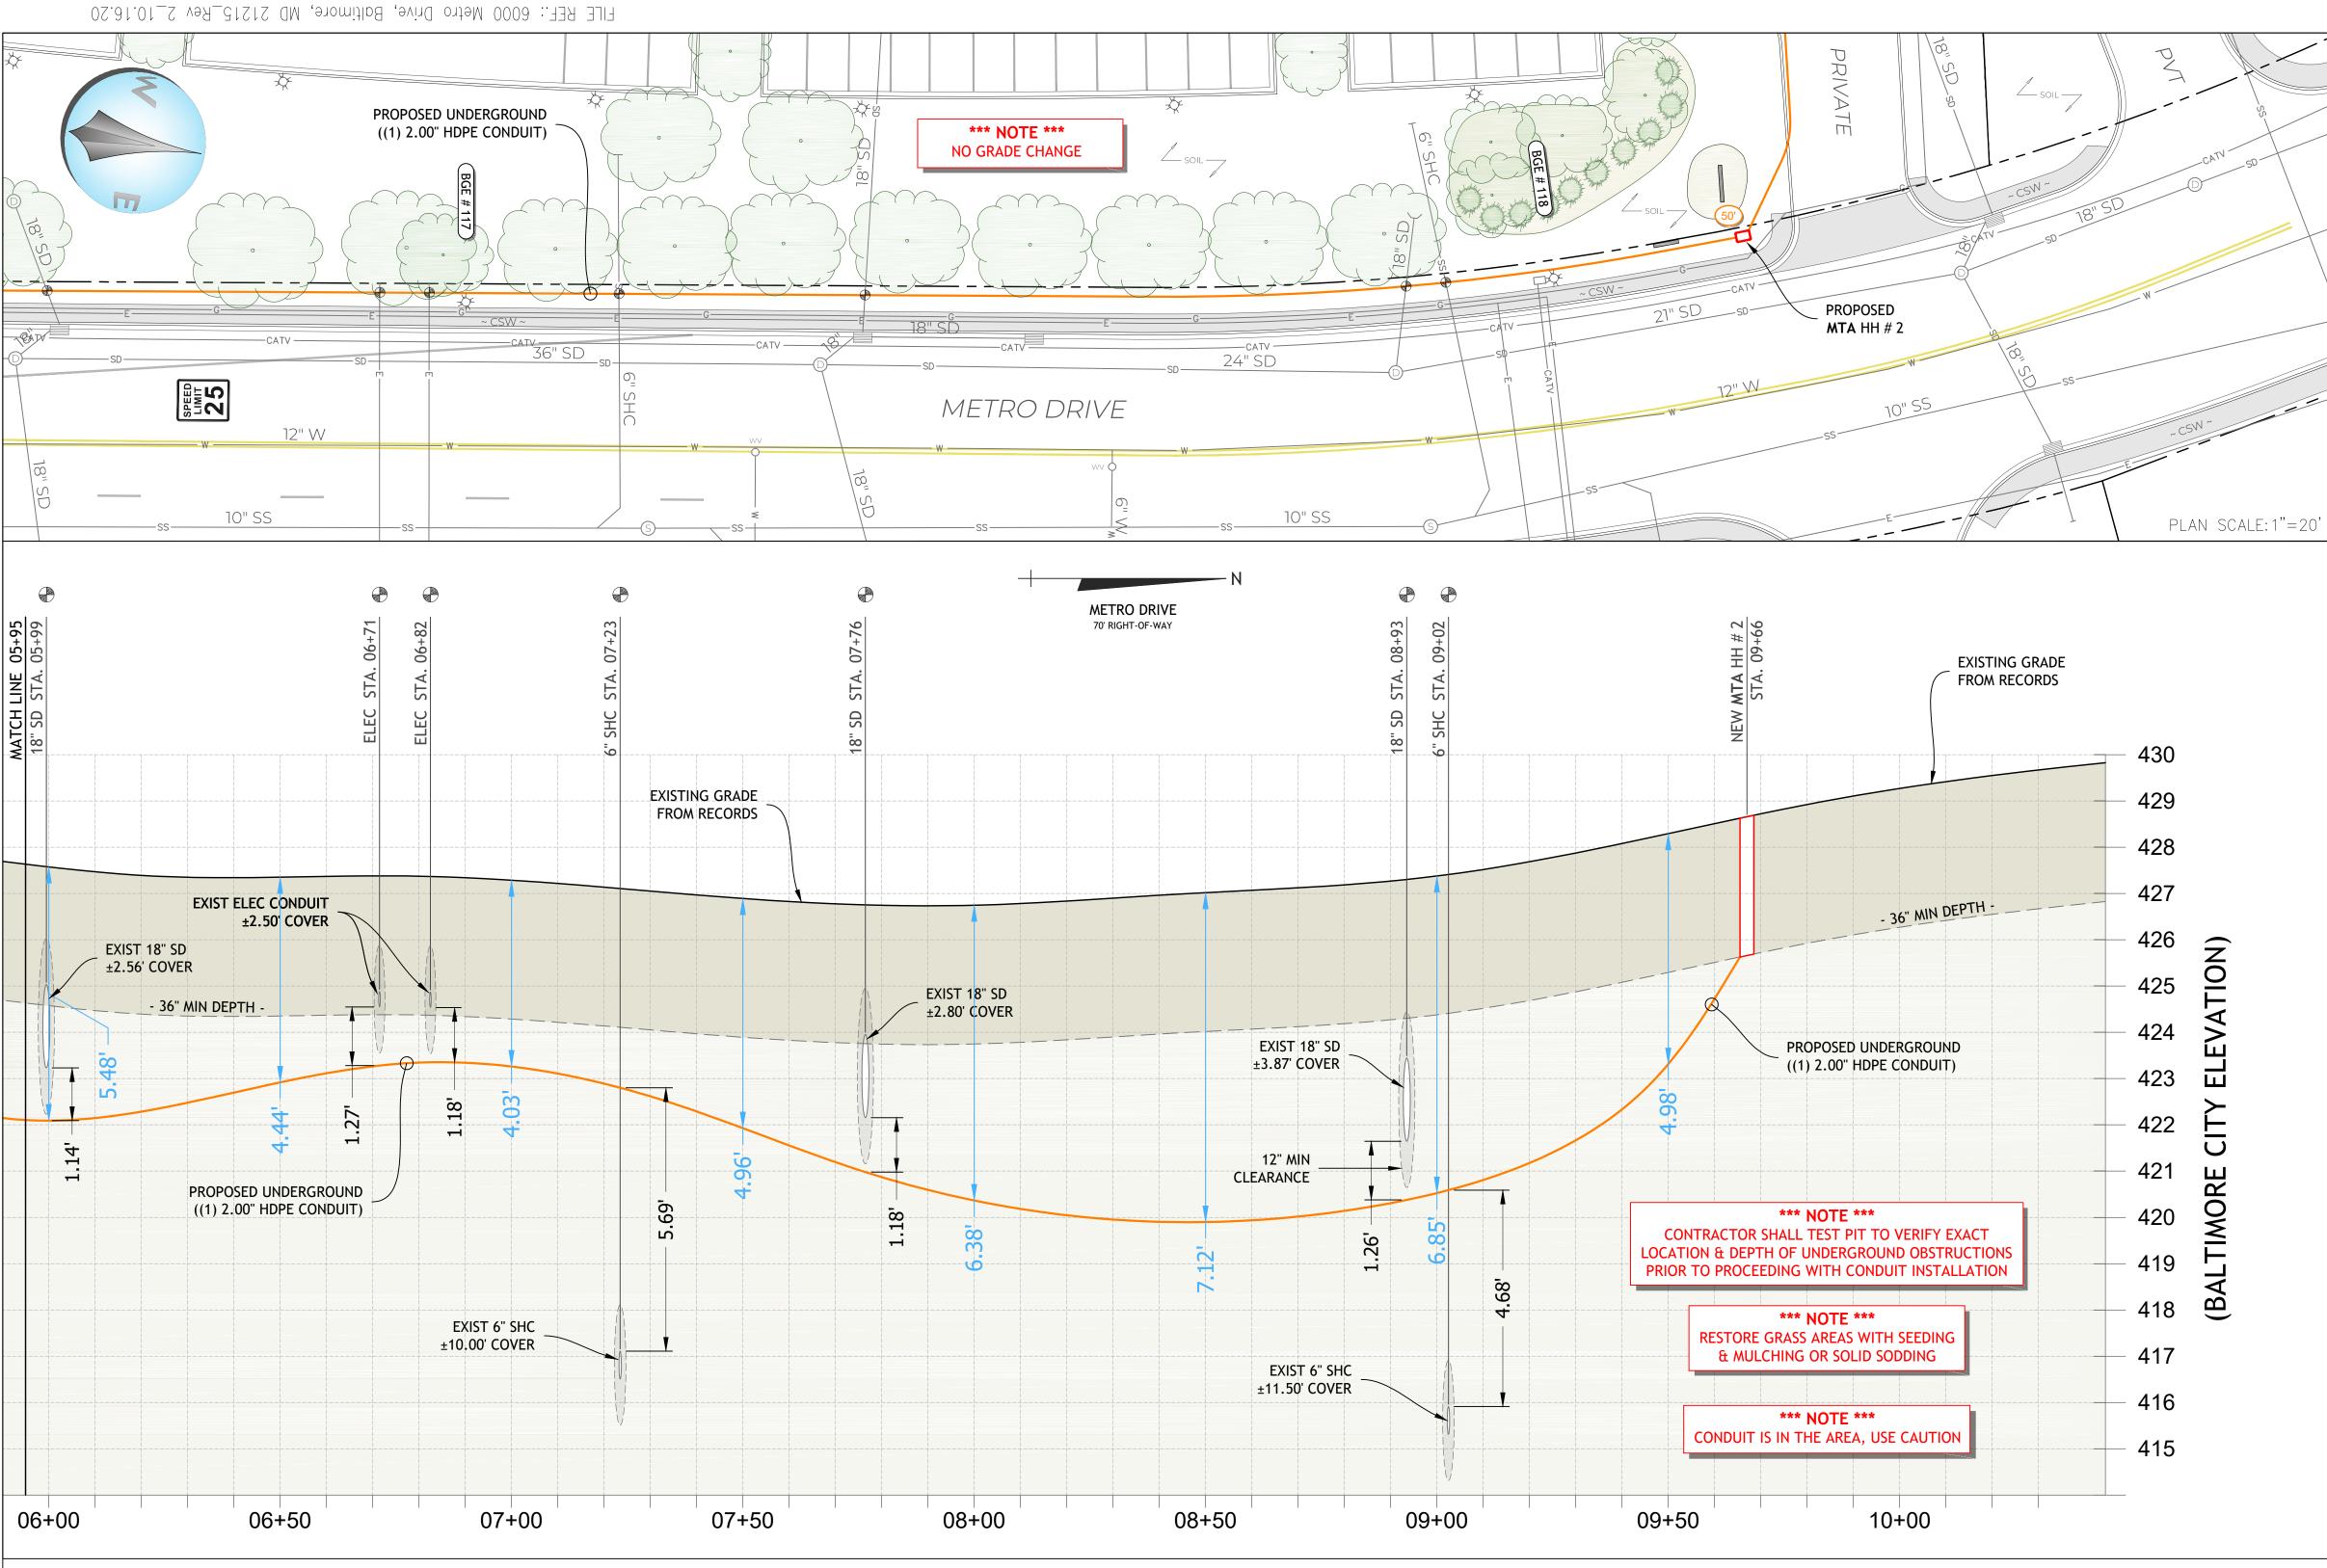

HORIZ. SCALE:1"=20' VERT. SCALE: 1"=2"

Director, Department of Transportation

Director, Department of Public Works





SEDIMENT AND EROSION CONTROL CONDUIT

WASTE WATER ENGINEERING

WATER ENGINEERING SIGNAL ENGINEERING

GRADE ESTABLISHMENT

-
$\overline{\mathbf{z}}$
5
\underline{O}
ح
5
ш
Ш
\square
$\overline{\mathbf{U}}$
ш
R
F
\mathbf{S}
2
$\widehat{\mathbf{M}}$

6000 METRO LLC OWNER:


6000 METRO LLC APPLICANT:

CITY OF BALTIMORE

DEVELOPER'S AGREEMENT No. 1676

6000 METRO LLC 6000 METRO DRIVE BALTIMORE, MD 21215

DATE: 10/16/2020 SCALE: NTS DRAWING: MTA-6000-MD SHEET: 8 OF 9 FILE REF.: 6000 Metro Drive, Baltimore, MD 21215_Rev 2_10.16.20

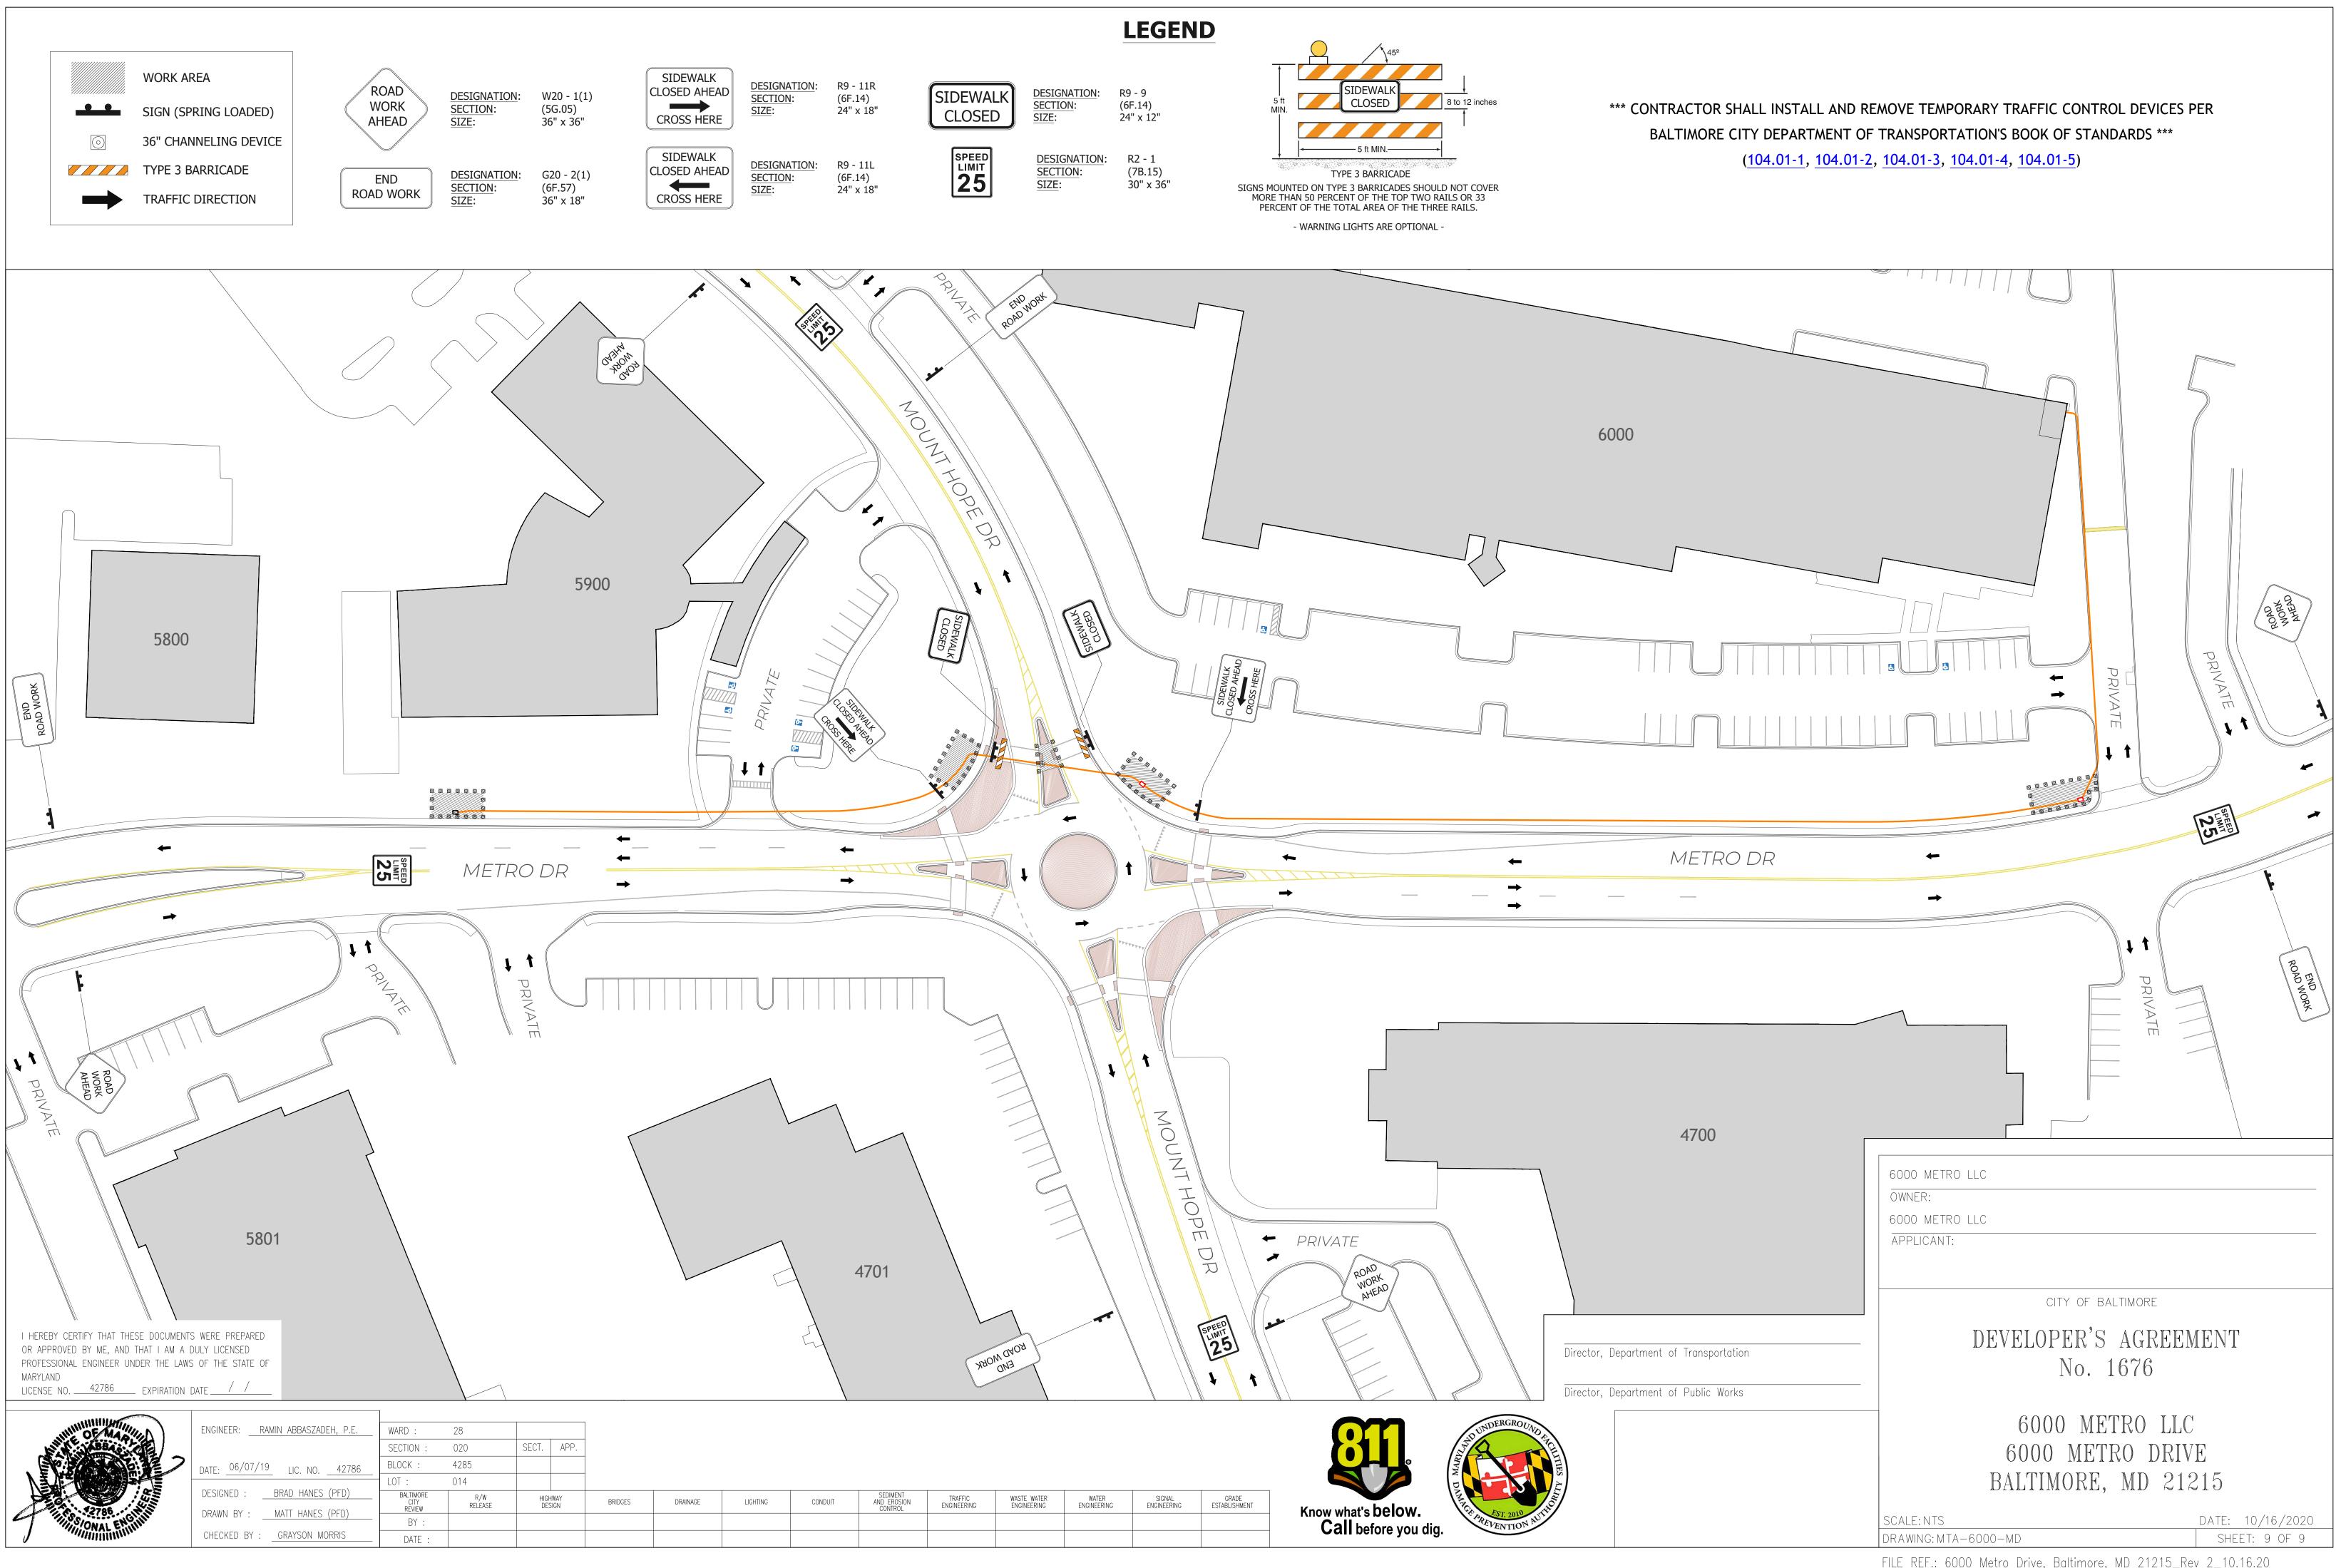

FILE REF.: 6000 Metro Drive, Baltimore, MD 21215_Rev 2_10.16.20